17 Dec 2019

Building Division

Invercargill City
Council
Building Consent
Authority
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Approved For Issue 27/02/2020

BUILDING CONSENT NUMBER

2019/1381

INVERCARGILL CENTRAL 33 ESK STREET

MECHANICAL SERVICES ZONE 1 UPDATED CONSENT ISSUE

DRAWING INDEX

| NUMBER | NAME | ISSUE | AMENDMENT | DATE |
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| M-0001 | STANDARD SYMBOLS LEGEND & DETAILS | D | CONSENT ISSUE | 11.10.19 |
| M-1101 | DUCTWORK LAYOUT GROUND FLOOR PART 1 | Е | UPDATED CONSENT ISSUE | 24.10.19 |
| M-1102 | DUCTWORK LAYOUT GROUND FLOOR PART 2 | E | UPDATED CONSENT ISSUE | 24.10.19 |
| M-1103 | DUCTWORK LAYOUT LEVEL 1 PART 1 | E | UPDATED CONSENT ISSUE | 24.10.19 |
| M-1104 | DUCTWORK LAYOUT LEVEL 1 PART 2 | Е | UPDATED CONSENT ISSUE | 24.10.19 |
| M-1105 | DUCTWORK LAYOUT LEVEL 2 & ROOF PART 1 | D | CONSENT ISSUE | 11.10.19 |
| M-1106 | DUCTWORK LAYOUT ROOF PART 2 | Е | UPDATED CONSENT ISSUE | 24.10.19 |
| M-1107 | DUCTWORK LAYOUT CHILDCARE ROOF | В | CONSENT ISSUE | 11.10.19 |
| M-1201 | PIPEWORK & CONTROLS LAYOUT GROUND FLOOR PART 1 | В | CONSENT ISSUE | 11.10.19 |
| M-1202 | PIPEWORK & CONTROLS LAYOUT GROUND FLOOR PART 2 | В | CONSENT ISSUE | 11.10.19 |
| M-1203 | PIPEWORK & CONTROLS LAYOUT LEVEL 1 PART 1 | В | CONSENT ISSUE | 11.10.19 |
| M-1204 | PIPEWORK & CONTROLS LAYOUT LEVEL 1 PART 2 | В | CONSENT ISSUE | 11.10.19 |
| M-1205 | PIPEWORK & CONTROLS LAYOUT LEVEL 2 PART 1 | В | CONSENT ISSUE | 11.10.19 |
| M-1206 | PIPEWORK & CONTROLS LAYOUT LEVEL 2 PART 2 | В | CONSENT ISSUE | 11.10.19 |
| M-1401 | MECHANICAL SCHEMATIC | С | UPDATED CONSENT ISSUE | 24.10.19 |



Environmental & Planning

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EXTRACT AIR

RETURN AIR

SUPPLY AIR TRANSFER AIR

UNINSULATED

25mm INTERNAL LINING

50mm INTERNAL LINING

25mm EXTERNAL LINING

FROM LEVEL ABOVE

FROM LEVEL BELOW

HIGH LEVEL LOW LEVEL

TO LEVEL ABOVE TO LEVEL BELOW

ROOF COWL

DOOR GRILLE

EQUIPMENT REFERENCE

REFERS TO EQUIPMENT ABBREVIATION

REFERS TO LEVEL (GROUND FLOOR)

REFERS TO EQUIPMENT NUMBER

AIR CONDITIONING UNIT

HEAT RECOVERY VENTILATION

AIR HANDLING UNIT

FAN COIL UNIT

SUPPLY FAN

EXTRACT FAN

HEATER BATTERY

HEATING COIL

COOLING COIL

PIPE RUNS BELOW FLOOR / GROUND

DIRECTION OF FLOW PIPE TO LEVEL ABOVE

PIPE TO LEVEL BELOW PIPE FROM LEVEL ABOVE PIPE FROM LEVEL BELOW

PIPE DROPS TO LOW LEVEL

PIPE RUNS IN CEILING SPACE

PIPE RISES TO HIGH LEVEL

PIPEWORK SYSTEM ABBEVIATIONS

CONDENSATE

REFRIGERANT

CHILLED WATER FLOW

CHILLED WATER RETURN

HEATING WATER FLOW

HEATING WATER RETURN

→ S.U. → PIPE SETS UP

PIPE TEES UP

CD

CHW-f

CHW-r

HTG-f

HTG-r

RFGT

S.D. PIPE SETS DOWN

LOUVRE

ABOVE FINISHED FLOOR LEVEL

OUTDOOR AIR

HVAC ABBREVIATION

O (PREFIX)

R (PREFIX)

S (PREFIX)

T (PREFIX)

/1 (SUFFIX)

/2 (SUFFIX)

/3 (SUFFIX)

/4 (SUFFIX)

F.A.

H.L.

L.L.

T.A.

DG

AC-G.01

AC-#.##

##-G.##

##-#.01

AC

AHU


HRV

FCU

PIPEWORK SYMBOLS

---- EXISTING PIPEWORK


| | SUPPORT STRAP FIXED TO STRUCTURE WITH SUITABLE FIXINGS 25mm GALV STEEL SUPPORT STRAP | — FIX DUCT TO SPIGOT USING HEAT SHRINK, CLAMPING BANDS OR MECHANICAL FASTENERS. APPLY DUCT SEALANT BETWEEN SPIGOT AND DUCT. FINISH WITH TWO COMPLETE WRAPS OF 50mm WIDE DUCT TAPE. |
|--|---|---|
| 1500 max BETWEEN SUPPORT STRAPS 300 min 7 SUPPORT | / | INTERNALLY LINED SIDE ENTRY CUSHION HEAD BOX ATTACHED TO GRILLE/DIFFUSER SEISMICALLY SUPPORTED FROM THE PRIMARY STRUCTURE |
| FLEXIBLE DUCT WITH 25mm INSULATED | | GRILLE/DIFFUSER IN CEILING |
| TYPICAL A | NR CUSHION BOX DETA SCALE: N.T.S. | <u>AIL</u> |

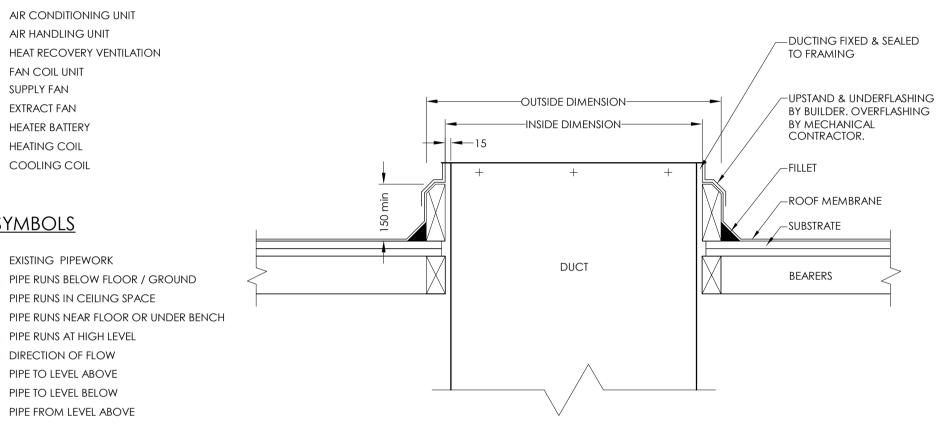


TYPICAL ROOF PENETRATION DETAIL

NOTE:

DAMPER INSTALLATION TO BE IN ACCORDANCE WITH THE MANUFACTURERS RECOMMENDATIONS; AS TESTED.

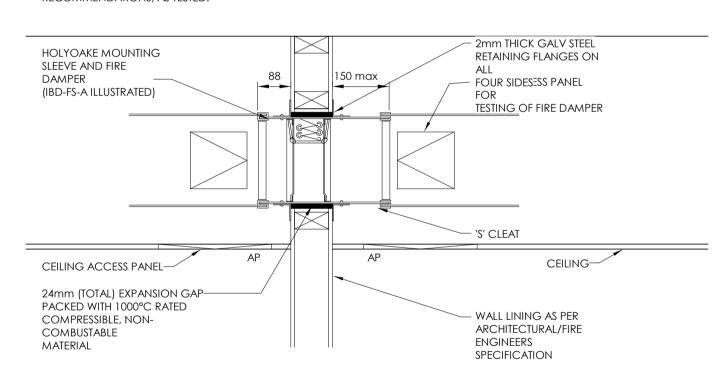

TYPICAL FIRE DAMPER DETAIL (PLASTERBOARD WALL) SCALE: N.T.S.

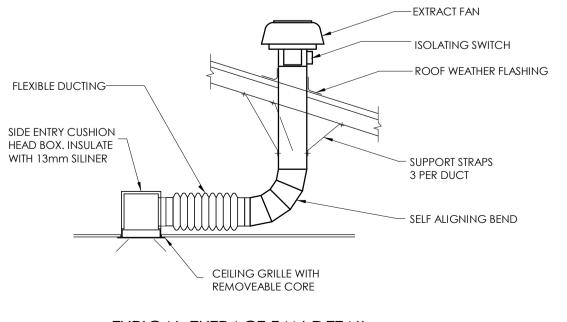


TYPICAL EXTRACT FAN DETAIL


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NOTE:


DAMPER INSTALLATION TO BE IN ACCORDANCE WITH THE MANUFACTURERS RECOMMENDATIONS; AS TESTED

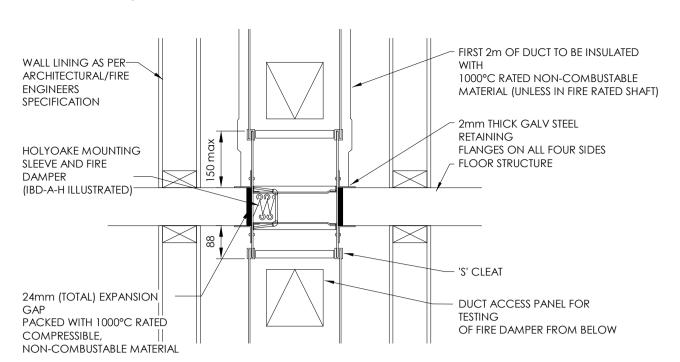

TYPICAL FIRE DAMPER DETAIL

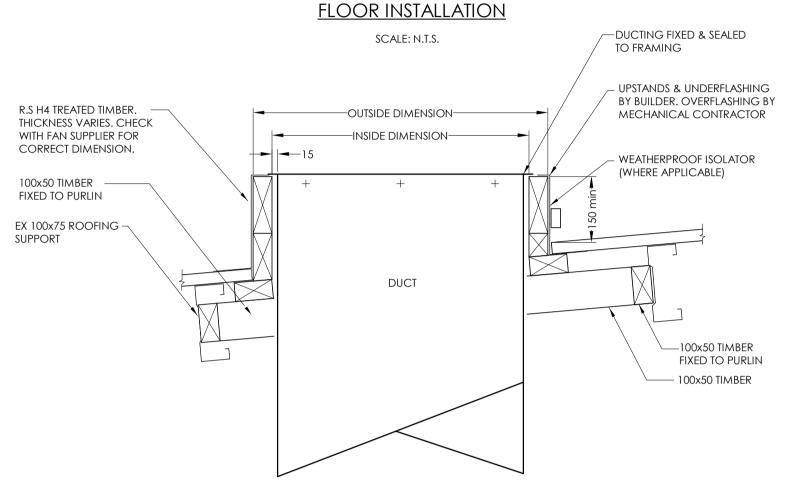

TYPICAL ROOF PENETRATION DETAIL

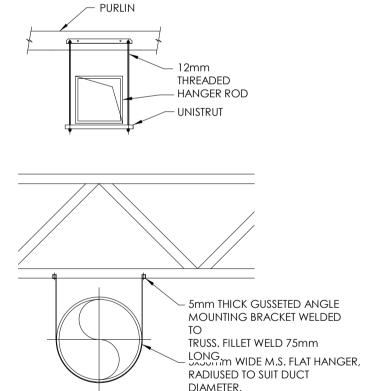

TYPICAL DUCT SUPPORT DETAIL

SCALE: N.T.S.

BUILDING CONSENT NUMBER

FURTHER INFORMATION.


SOME SYMBOLS ON THIS LEGEND MAY NOT BE APPLICABLE TO THIS PROJECT.

REFER TO ARCHITECTURAL REFLECTED CEILING

PLANS FOR SET-OUT OF ALL CEILING MOUNTED

REFER TO ARCHITECTURAL ELEVATIONS FOR SET-OUT OF ALL MECHANICAL SERVICES.

REFER TO THE ENGINEERS SPECIFICATION FOR

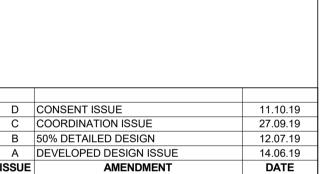

CHECK ALL INFORMATION ON SITE PRIOR TO COMMENCING WORK. READ IN CONJUNCTION WITH THE SPECIFICATION AND OTHER RELEVANT DRAWINGS AND DOCUMENTS



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INVERCARGILL CENTRAL 33 ESK STREET ZONE 1

STANDARD SYMBOLS LEGEND & DETAILS

|--|

| DESIGNED | SF | DATE: | 11.10.19 | |
|-----------|-----|---------|-----------|--|
| DRAWN: | RC | SCALE @ | A1: 1:100 | |
| PROJECT I | No: | | | |

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EXTENT OF WORKS

ASSOCIATED WITH

TENANCIES

EXTENT OF WORKS ASSOCIATED WITH

ZONE 1 D.S.ANCHOR

ZONE 1 MALL RETAIL

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- MINIMUM 600x300 PLENUM TO REAR OF ARCHITECTURAL LOUVRE THROUGH BLANKING

DAC 1.02

SC56 DS ANCHOR WIND

1000x500R/2

1200x600S/2

FOR CONTINUATION REFER TO DWG M-1102

Ø300R/2

600x400R/2

600x600S/2

S1 250

S1 250 Ø400S/2

1000x600S/2

PLATE. (TYPICAL)

Ø300R/2

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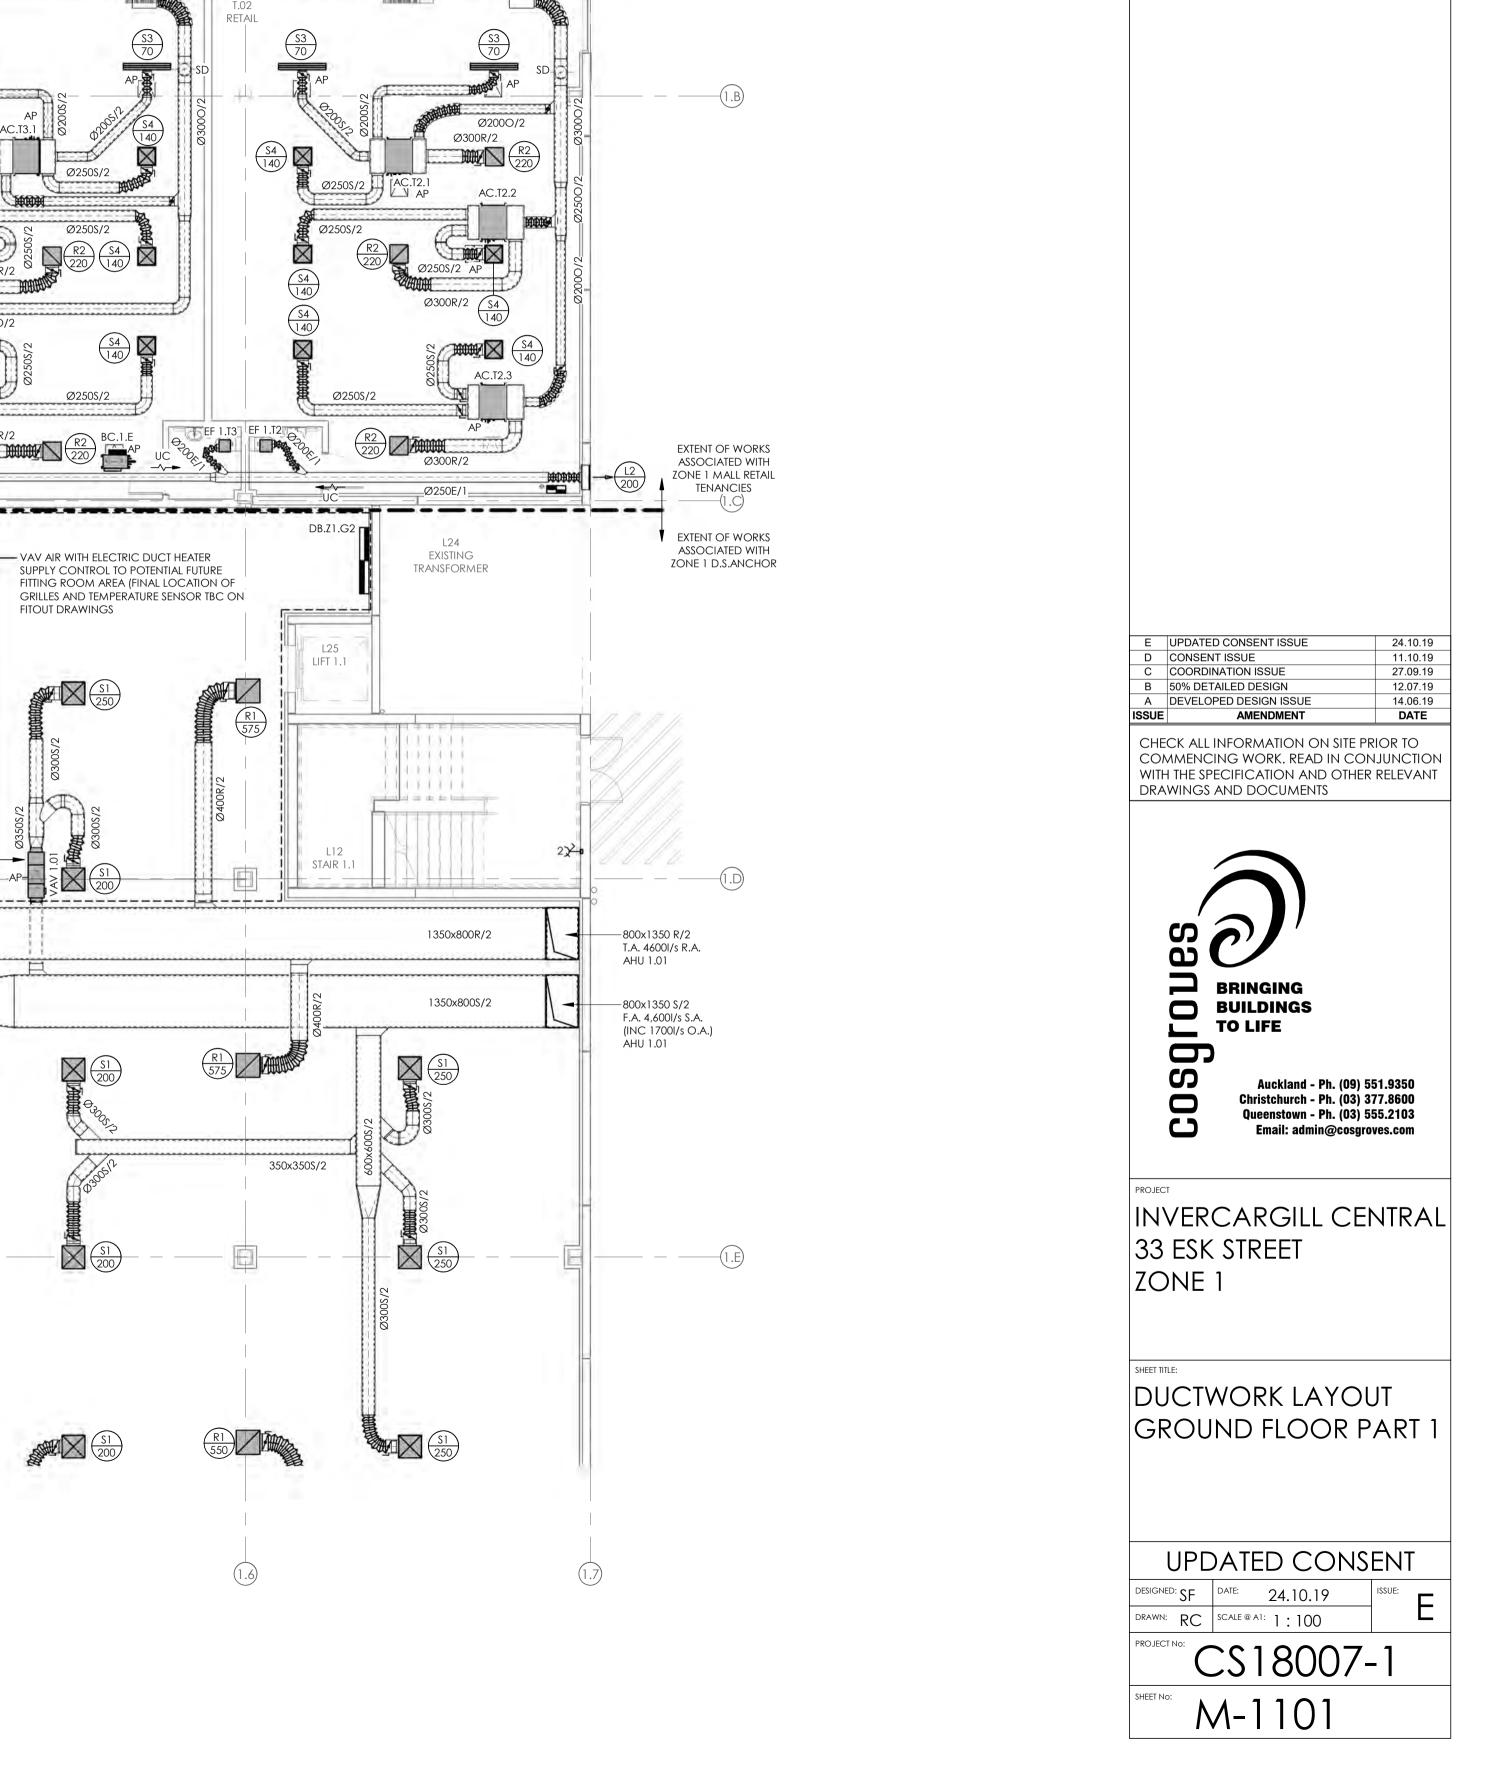
OTES:

REFER TO DRAWING M001 FOR STANDARD SYMBOLS LEGEND & DETAILS

REFER TO SPECIFICATION FOR FURTHER INFORMATION.

SUPPLY AIR DIFFUSERS ARE TO INCLUDE VOLUME CONTROL DAMPER AT CUSHION HEAD,

ADJUSTABLE VIA GRILLE FACE AS STANDARD.



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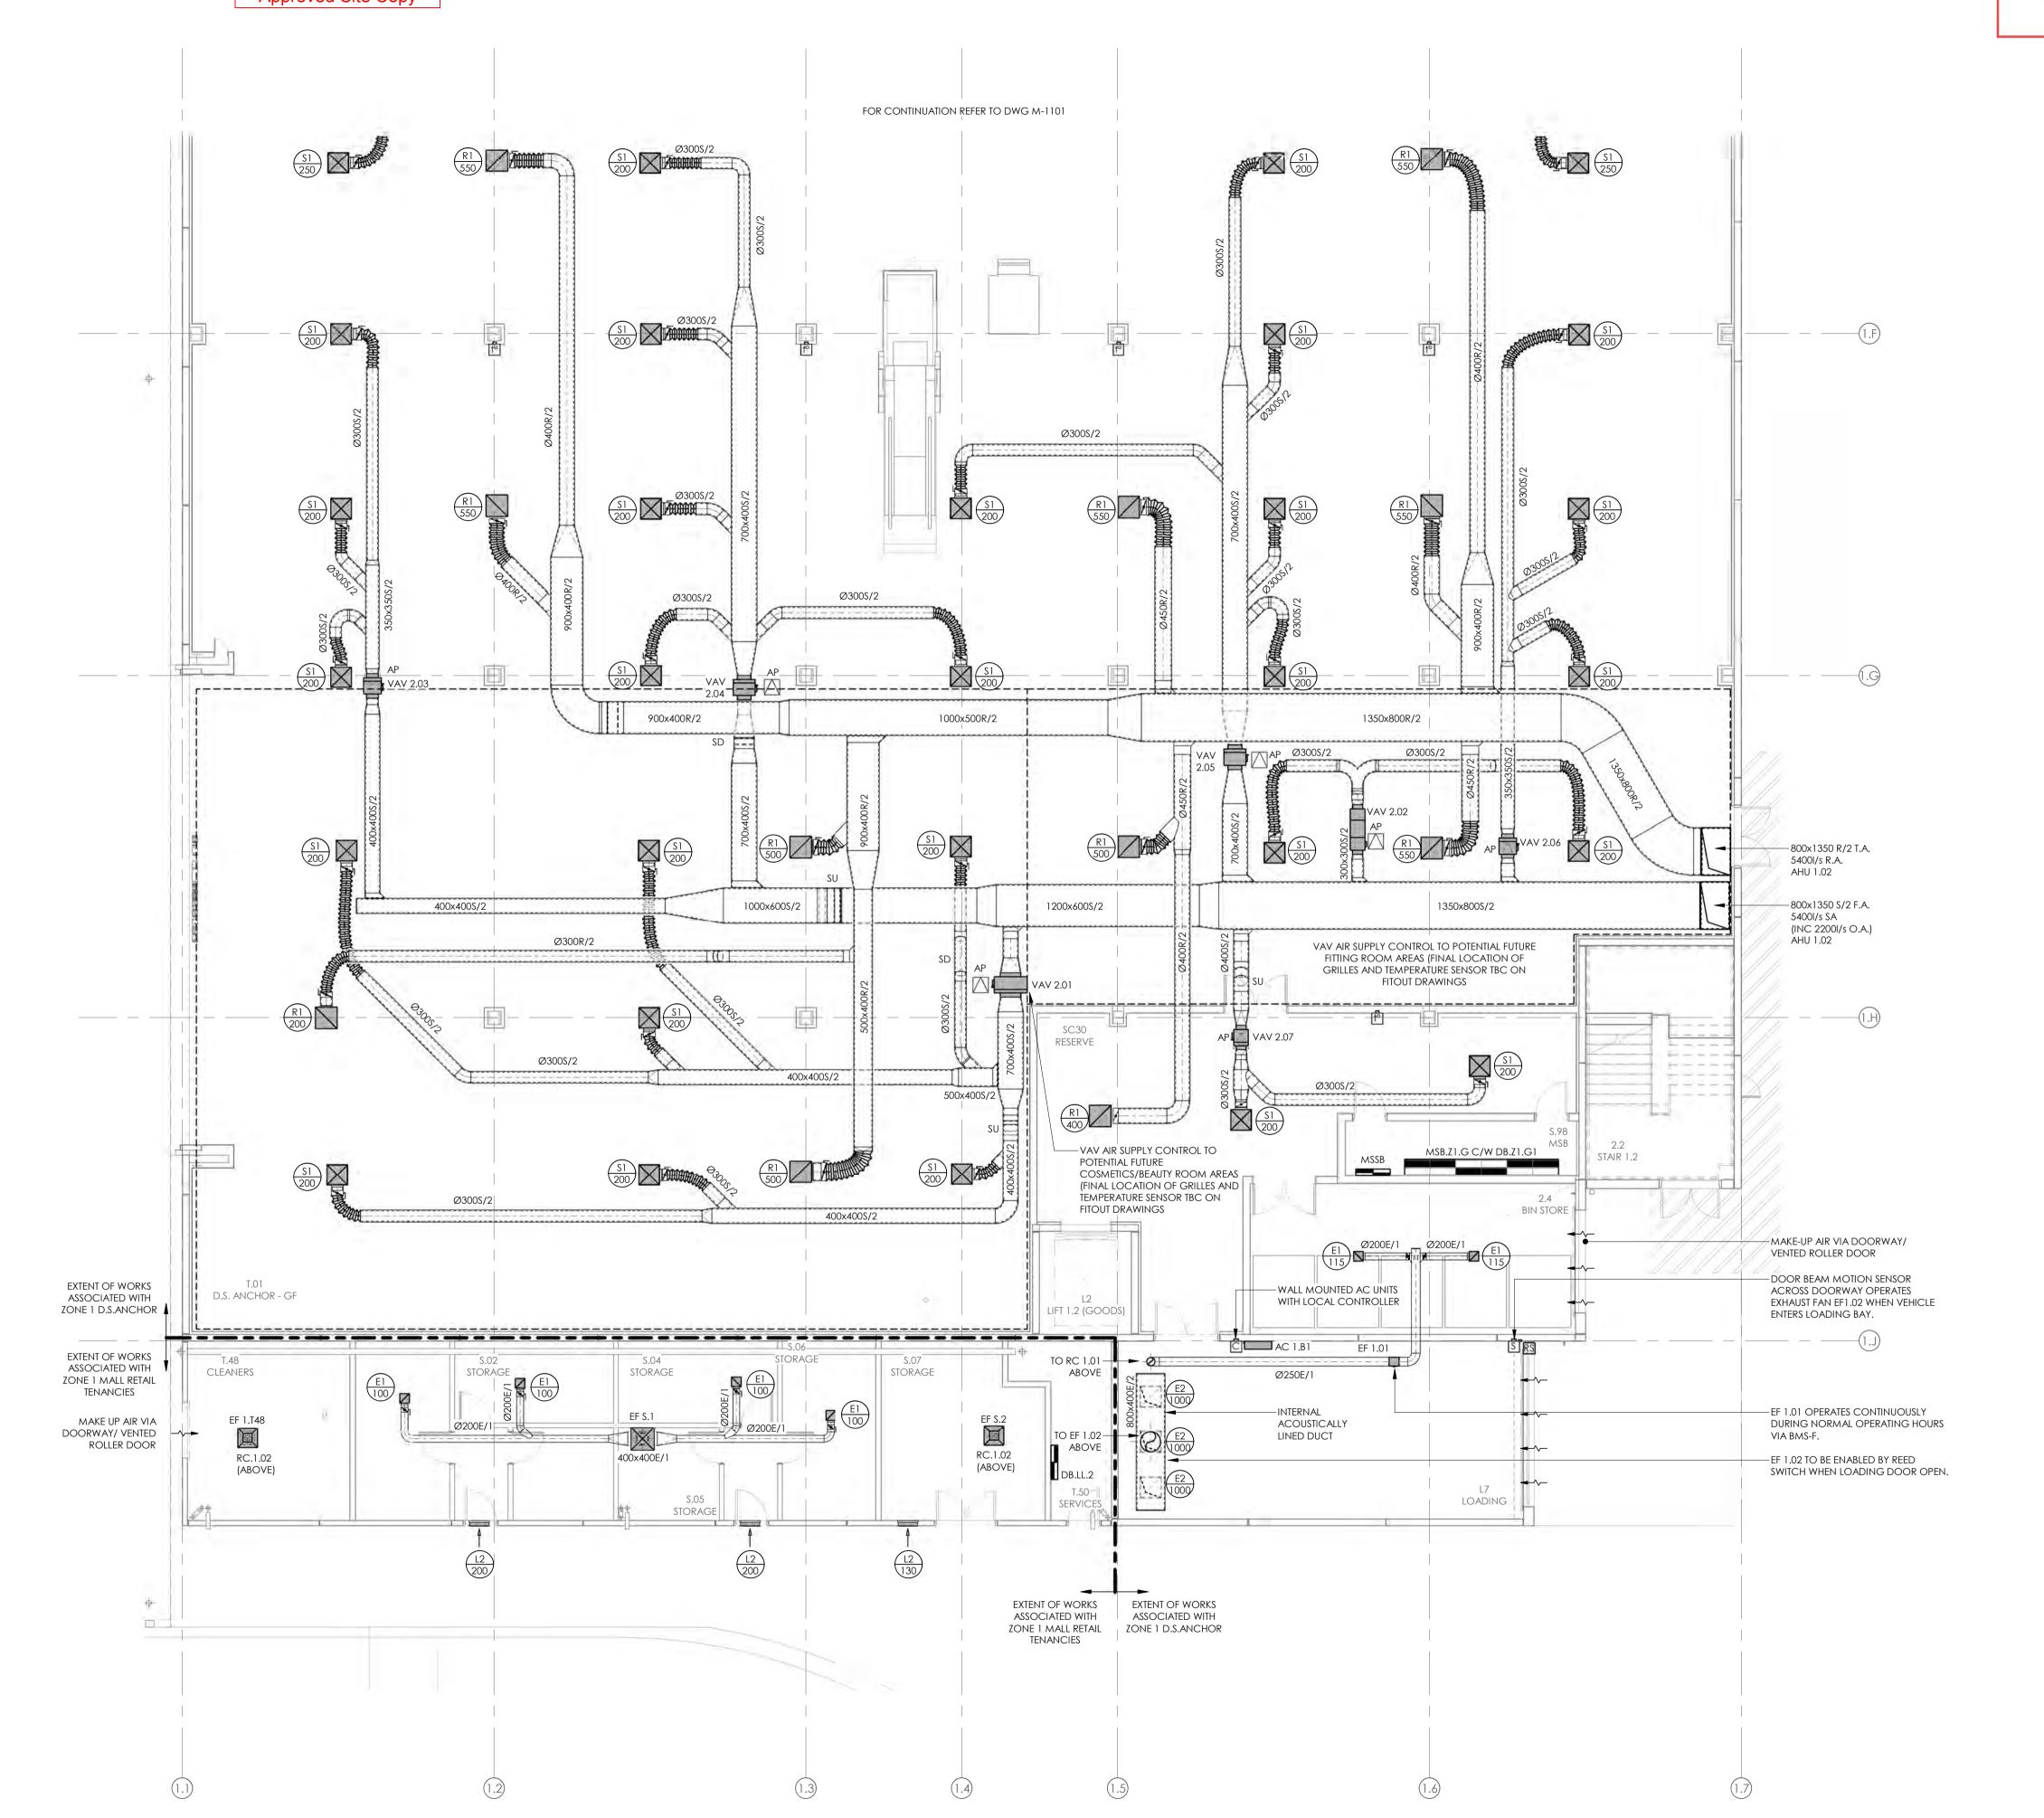
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SUPPLY AIR DIFFUSERS ARE TO INCLUDE VOLUME CONTROL DAMPER AT CUSHION HEAD, ADJUSTABLE VIA GRILLE FACE AS STANDARD.

EXHAUST FANS TO INCLUDE BACKDRAFT DAMPER AS STANDARD.



E UPDATED CONSENT ISSUE 24.10.19 D CONSENT ISSUE 27.09.19 C COORDINATION ISSUE B 50% DETAILED DESIGN 12.07.19 A DEVELOPED DESIGN ISSUE 14.06.19 AMENDMENT DATE

CHECK ALL INFORMATION ON SITE PRIOR TO COMMENCING WORK. READ IN CONJUNCTION WITH THE SPECIFICATION AND OTHER RELEVANT DRAWINGS AND DOCUMENTS




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INVERCARGILL CENTRAL 33 ESK STREET ZONE 1

DUCTWORK LAYOUT GROUND FLOOR PART 2

| UPC |)A ⁻ | TED | C | CONS | ENT |
|--------------|-----------------|-----|----|------|--------|
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2019/1381

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INVERCARGILL CENTRAL

33 ESK STREET ZONE 1

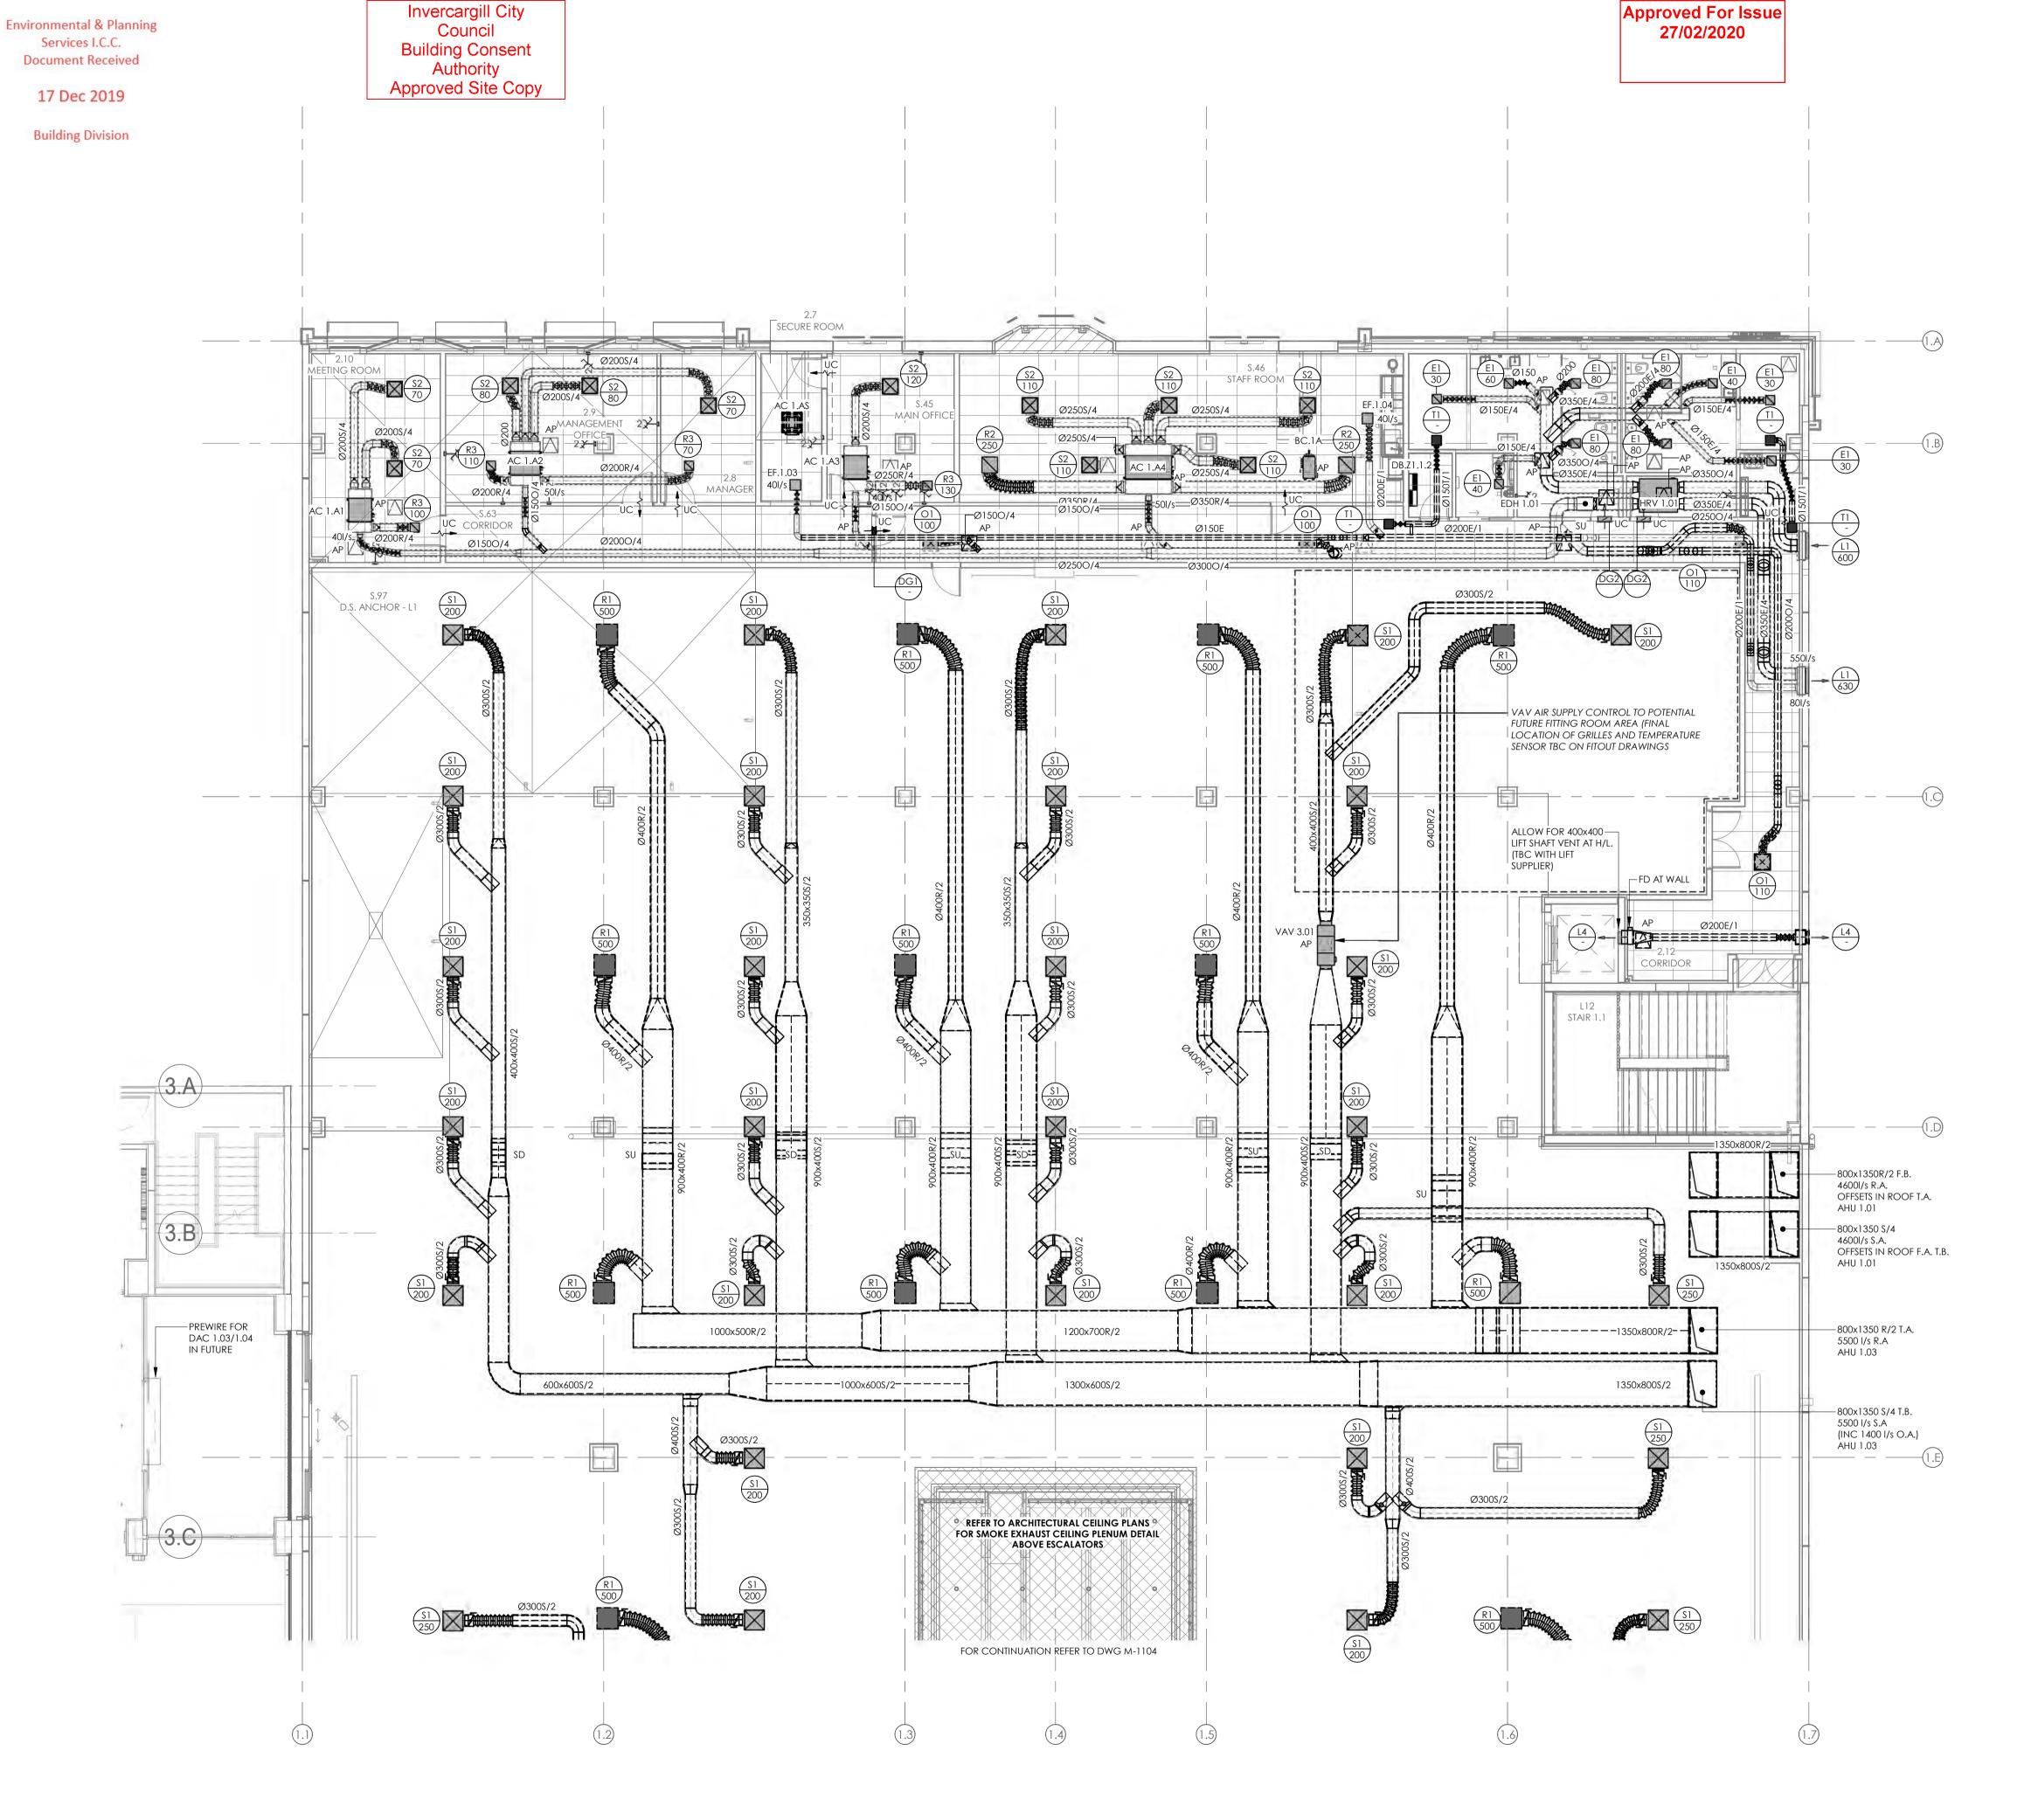DUCTWORK LAYOUT LEVEL 1 PART 1

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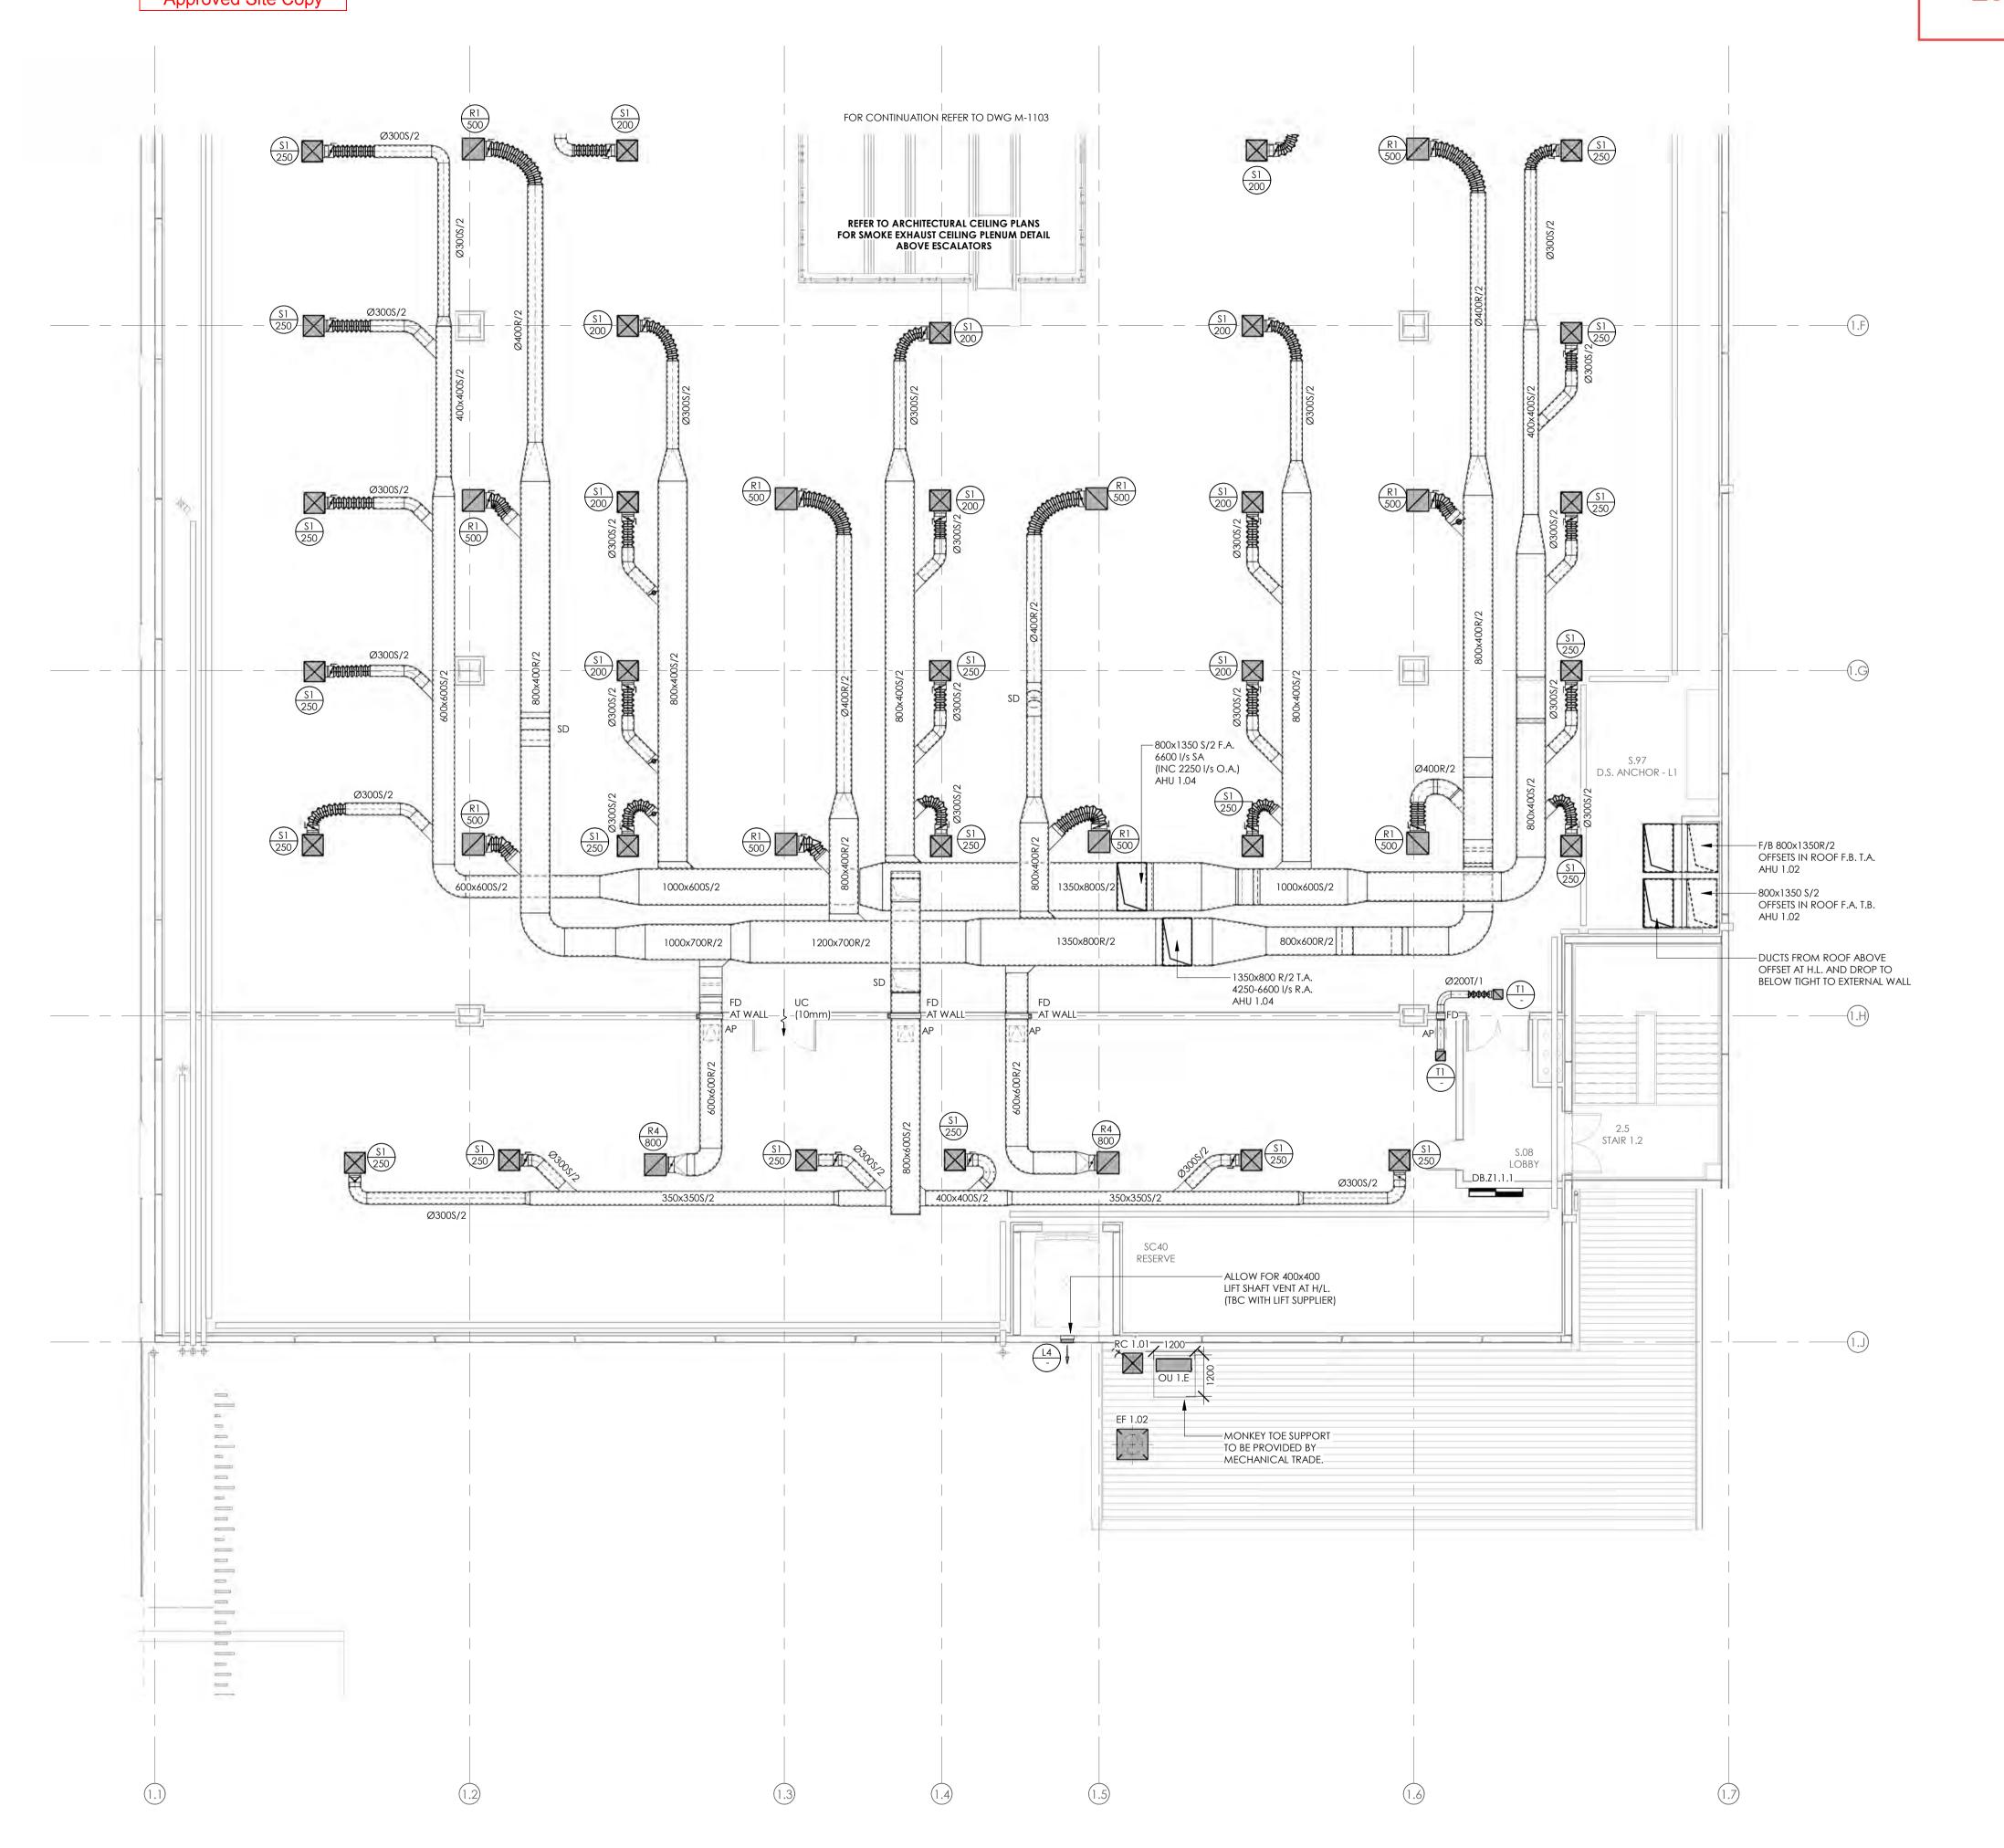
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SUPPLY AIR DIFFUSERS ARE TO INCLUDE VOLUME CONTROL DAMPER AT CUSHION HEAD, ADJUSTABLE VIA GRILLE FACE AS STANDARD.



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INVERCARGILL CENTRAL 33 ESK STREET ZONE 1

DUCTWORK LAYOUT LEVEL 1 PART 2

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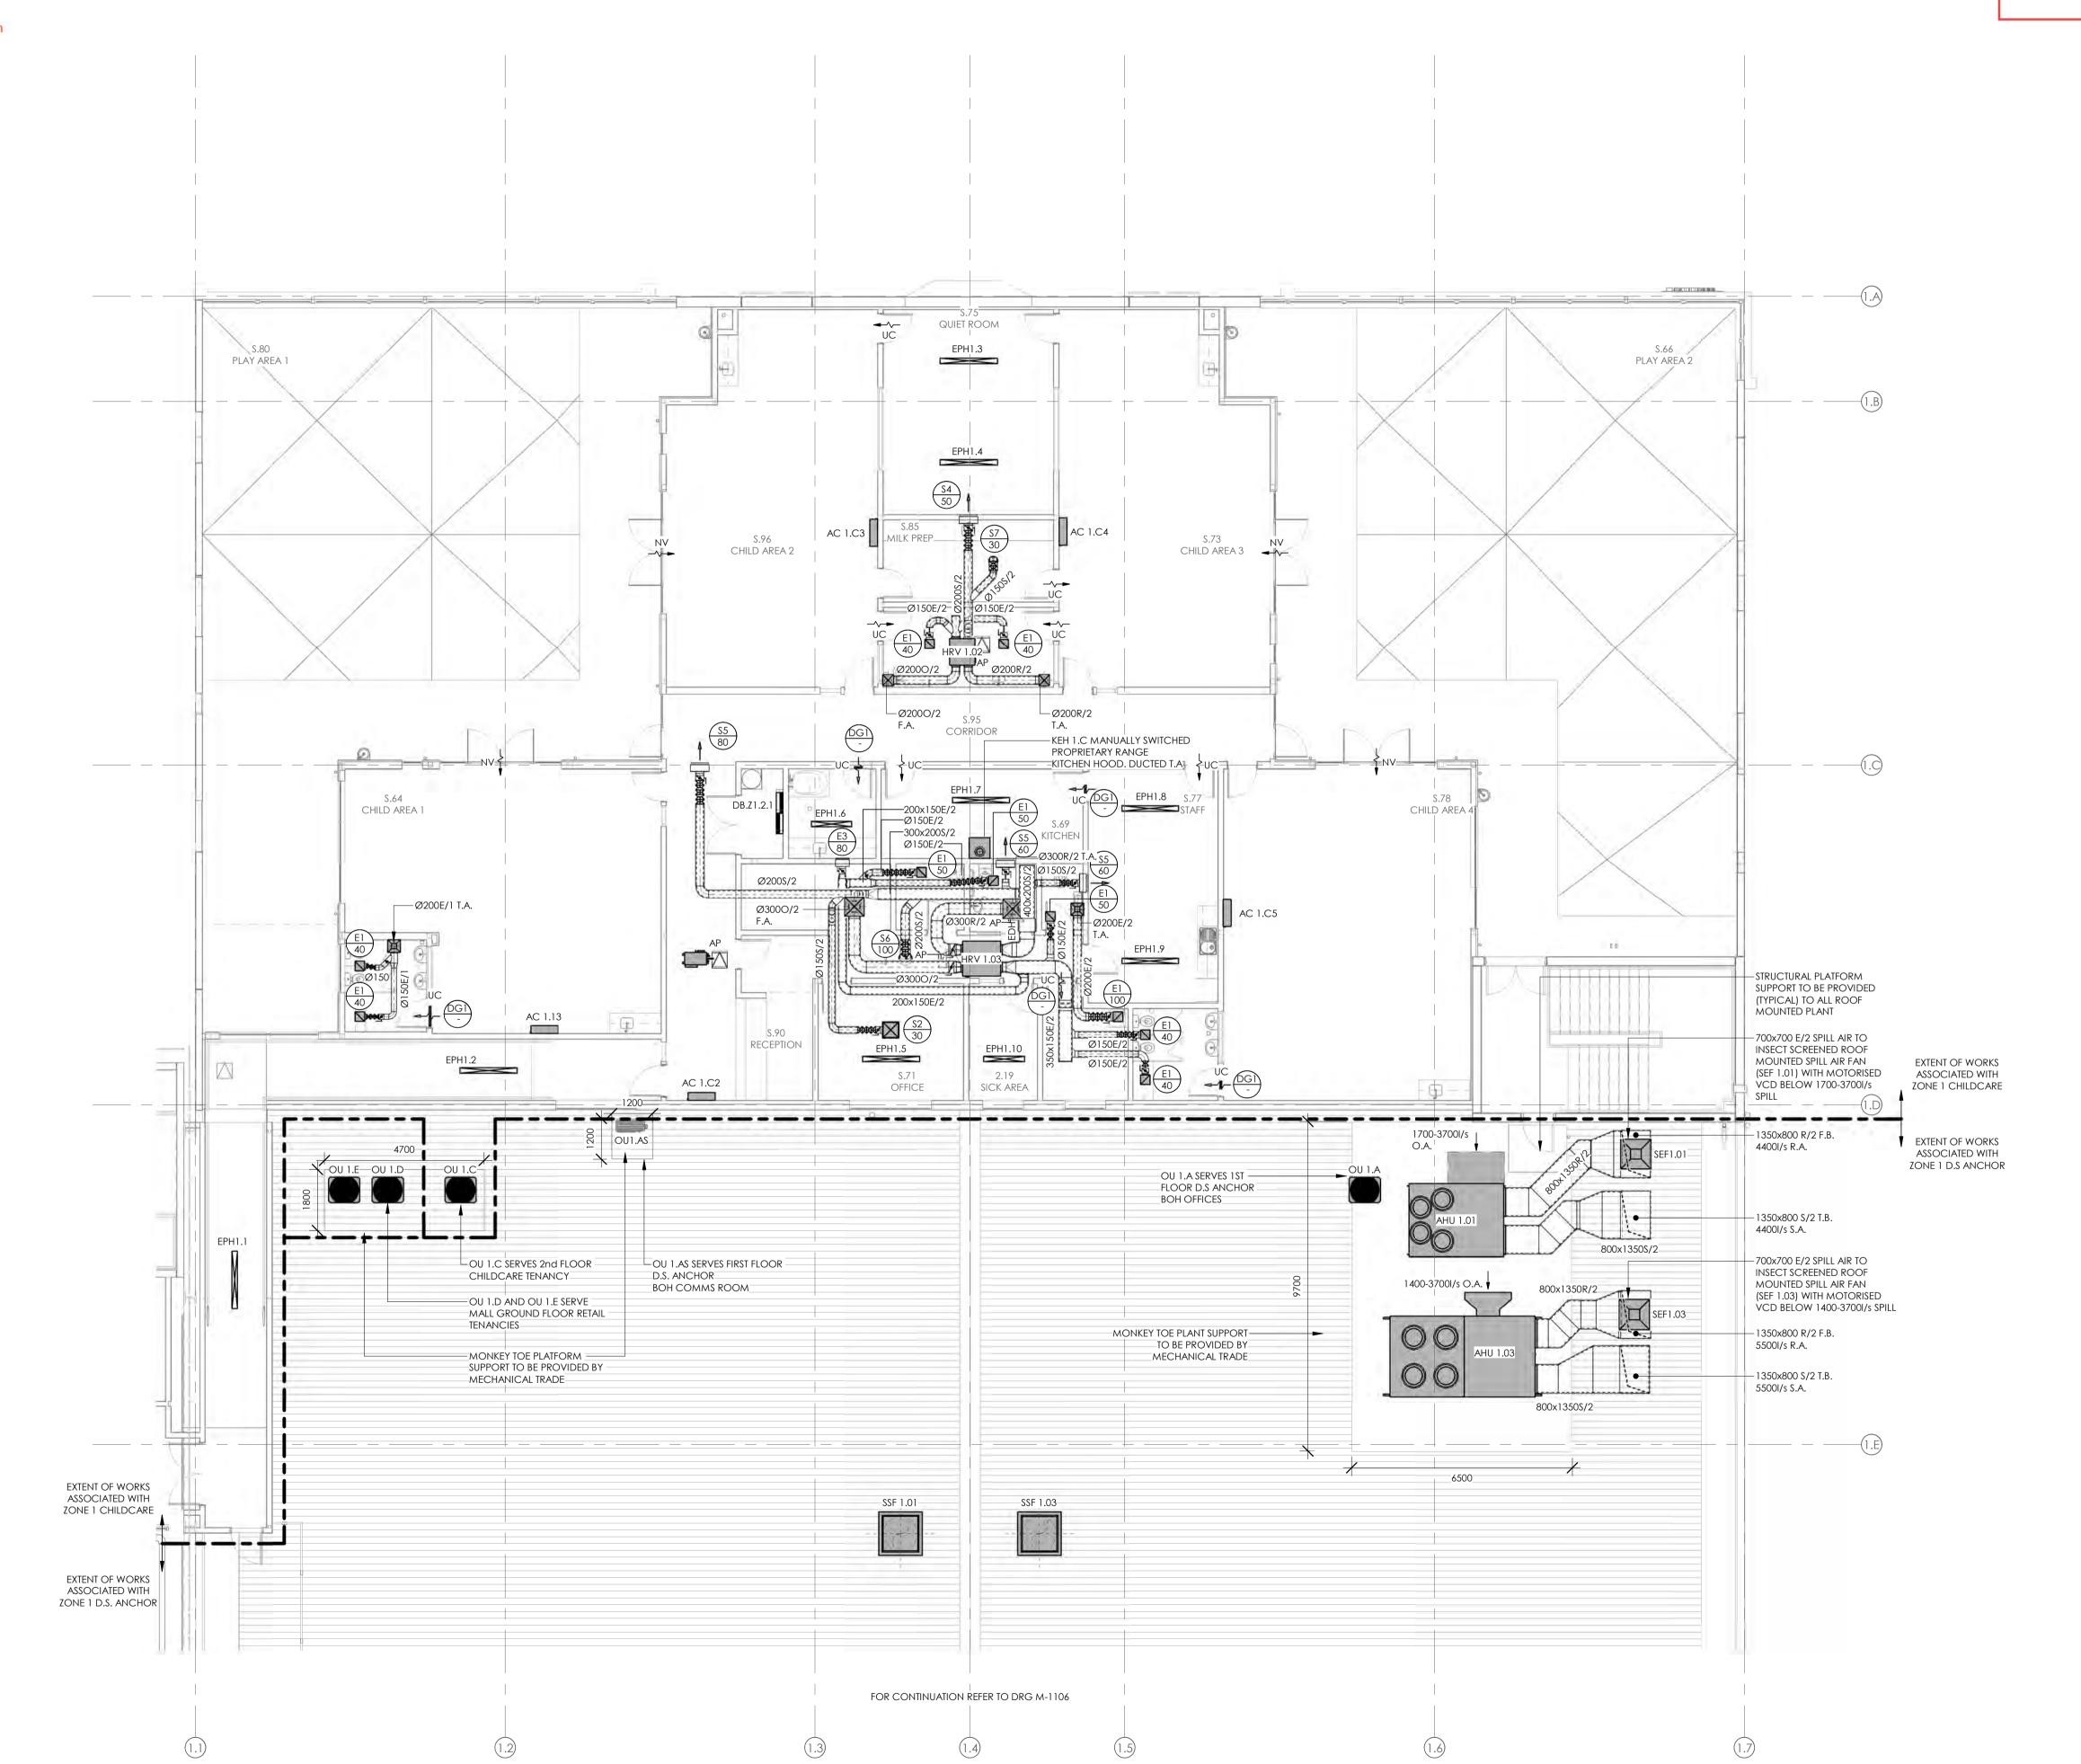
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REFER TO DRAWING M001 FOR STANDARD SYMBOLS LEGEND & DETAILS

REFER TO THE SPECIFICATION FOR FURTHER INFORMATION

REFER TO THE FIRE ENGINEERS REPORT FOR EXTENT OF FIRE SEPERATIONS AND ALLOW TO SEAL ALL PENETRATIONS THROUGH FIRE RATE BUILDING

4. DOOR UNDERCUTS (UC) SHALL TYPICALLY BE 20mm (MAX. 10mm ALLOWED TO FIRE DOORS).



| ISSUE | AMENDMENT | DATE |
|-------|------------------------|----------|
| Α | DEVELOPED DESIGN ISSUE | 14.06.19 |
| В | 50% DETAILED DESIGN | 12.07.19 |
| С | COORDINATION ISSUE | 27.09.19 |
| D | CONSENT ISSUE | 11.10.19 |
| | | |

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INVERCARGILL CENTRAL
33 ESK STREET
ZONE 1

SHEET TITL

DUCTWORK LAYOUT LEVEL 2 & ROOF PART 1

| | C | ONSENT |
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| SF | DATE: | 11.10.19 |

PROJECT NO: C 1 Q 0 7 1

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REFER TO THE SPECIFICATION FOR FURTHER INFORMATION



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| Α | DEVELOPED DESIGN ISSUE | 14.06.19 |
| В | 50% DETAILED DESIGN | 12.07.19 |
| С | COORDINATION ISSUE | 27.09.19 |
| D | CONSENT ISSUE | 11.10.19 |
| E | UPDATED CONSENT ISSUE | 24.10.19 |
| | | |

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INVERCARGILL CENTRAL 33 ESK STREET ZONE 1

DUCTWORK LAYOUT ROOF PART 2

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DESIGNED: SF DATE: 24.10.19

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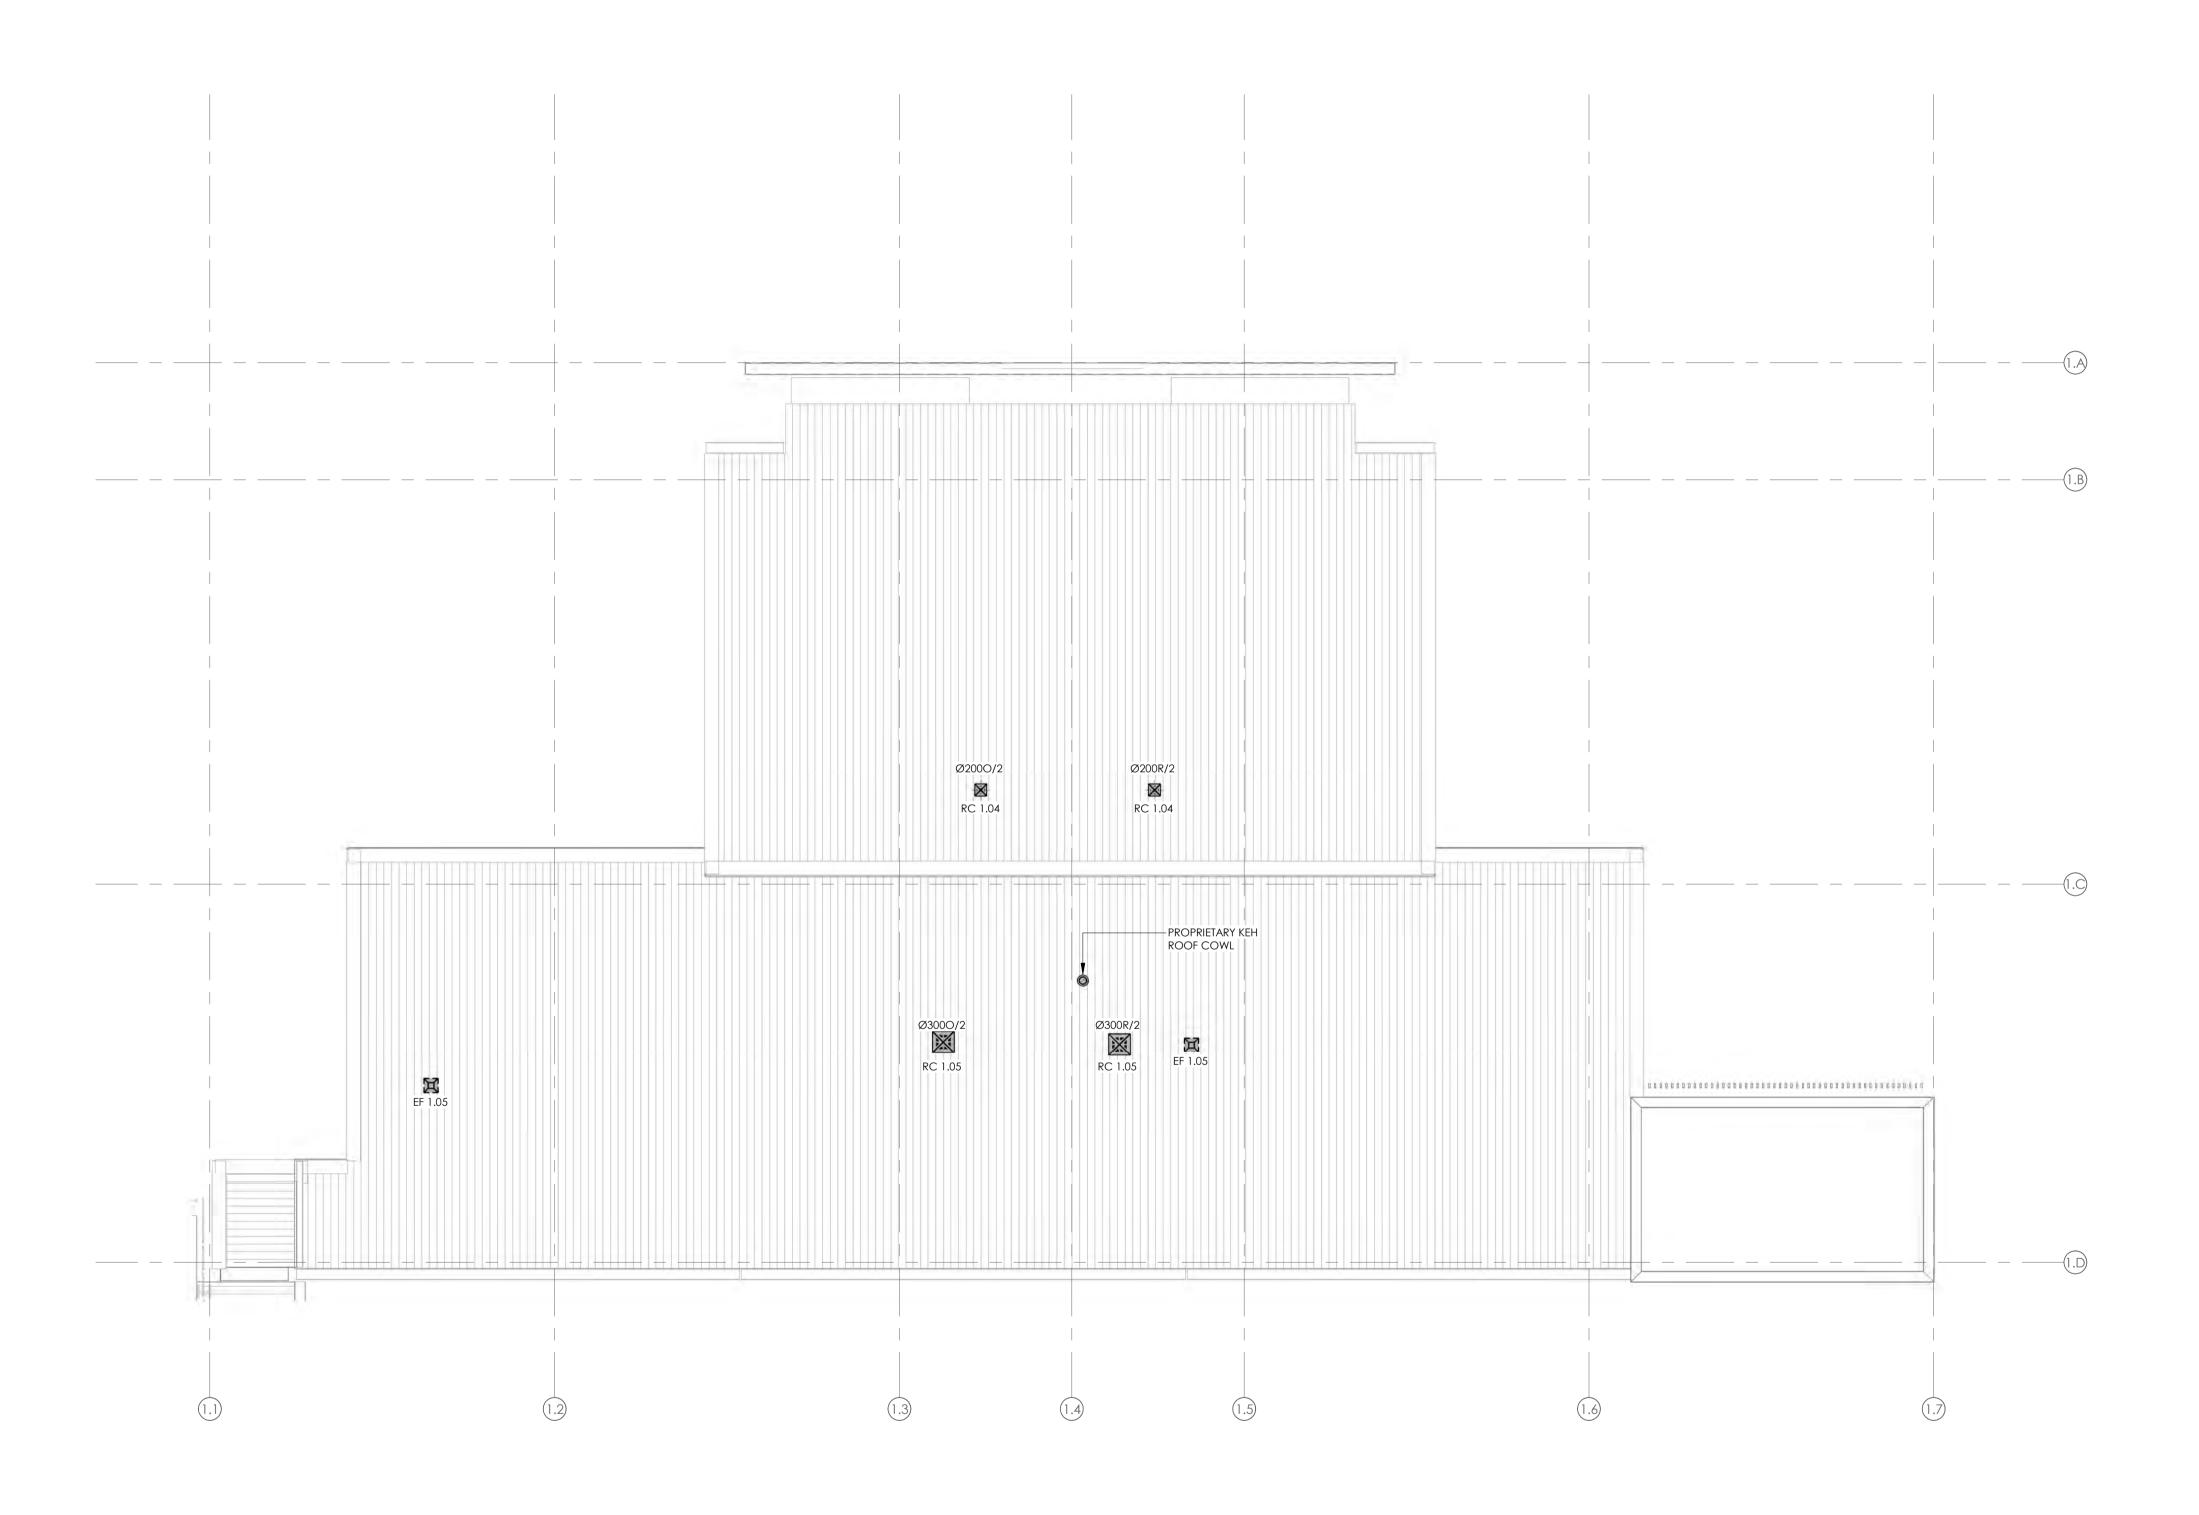
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| A | COORDINATION ISSUE | 27.09.19 |
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INVERCARGILL CENTRAL 33 ESK STREET

DUCTWORK LAYOUT CHILDCARE ROOF

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2019/1381

BUILDING CONSENT NUMBER

REFER TO DRAWING M001 FOR STANDARD SYMBOLS LEGEND & DETAILS

REFER TO MECHANICAL SERVICES SPECIFICATION FOR FURTHER DETAILS.

- AC AND HEATING SYSTEMS CONTROLS AND REMOTE TEMPERATURE SENSORS TO TYPICALLY BE INSTALLED AT 1200AFFL TO BOTTOM EDGE OF DEVICE. FINAL LOCATIONS TO BE CONFIRMED ON SITE PRIOR TO INSTALLATION TO TAKE ACCOUNT OF FINAL FITOUT LAYOUTS.
- REFER TO FIRE ENGINEERS REPORT FOR EXTENT OF FIRE SEPERATIONS AND ALLOW TO SEAL ALL PENETRATIONS THROUGH FIRE RATED BUILDING
- ALL D.S ANCHOR ROOFTOP PLANT AND CONTROLS SHALL BE PROVIDED WITH SUITABLE BACNET INTERFACE CARDS FOR CONNECTION TO THE FARMERS BUILDING MANAGEMENT SYSTEM (BMS.F, LOCATED IN THE ZONE 1 GROUND LEVEL MAIN SWITCHBOARD ROOM) VIA D.S ANCHOR LOCAL BACNET ETHERNET NETWORK TO ALLOW FOR REMOTE MONITORING AND ADJUSTMENT.
- ALL PLANT AND CONTROLS SERVING INVERCARGILL CENTRAL MALL RETAIL TENANCIES SHALL BE PROVIDED WITH SUITABLE BACNET INTERFACE CARDS FOR CONNECTION TO THE INVERCARGILL CENTRAL MALL BUILDING MANAGEMENT SYSTEM (BMS-M, TO BE LOCATED IN ZONE 2, LEVEL 1 CENTRE MANAGEMENT OFFICES) VIA SEPERATE MALL BACNET ETHERNET NETWORK TO ALLOW FOR REMOTE MONITORING AND ADJUSTMENT.

11.10.19 27.09.19 **DATE** B CONSENT ISSUE A COORDINATION ISSUE AMENDMENT

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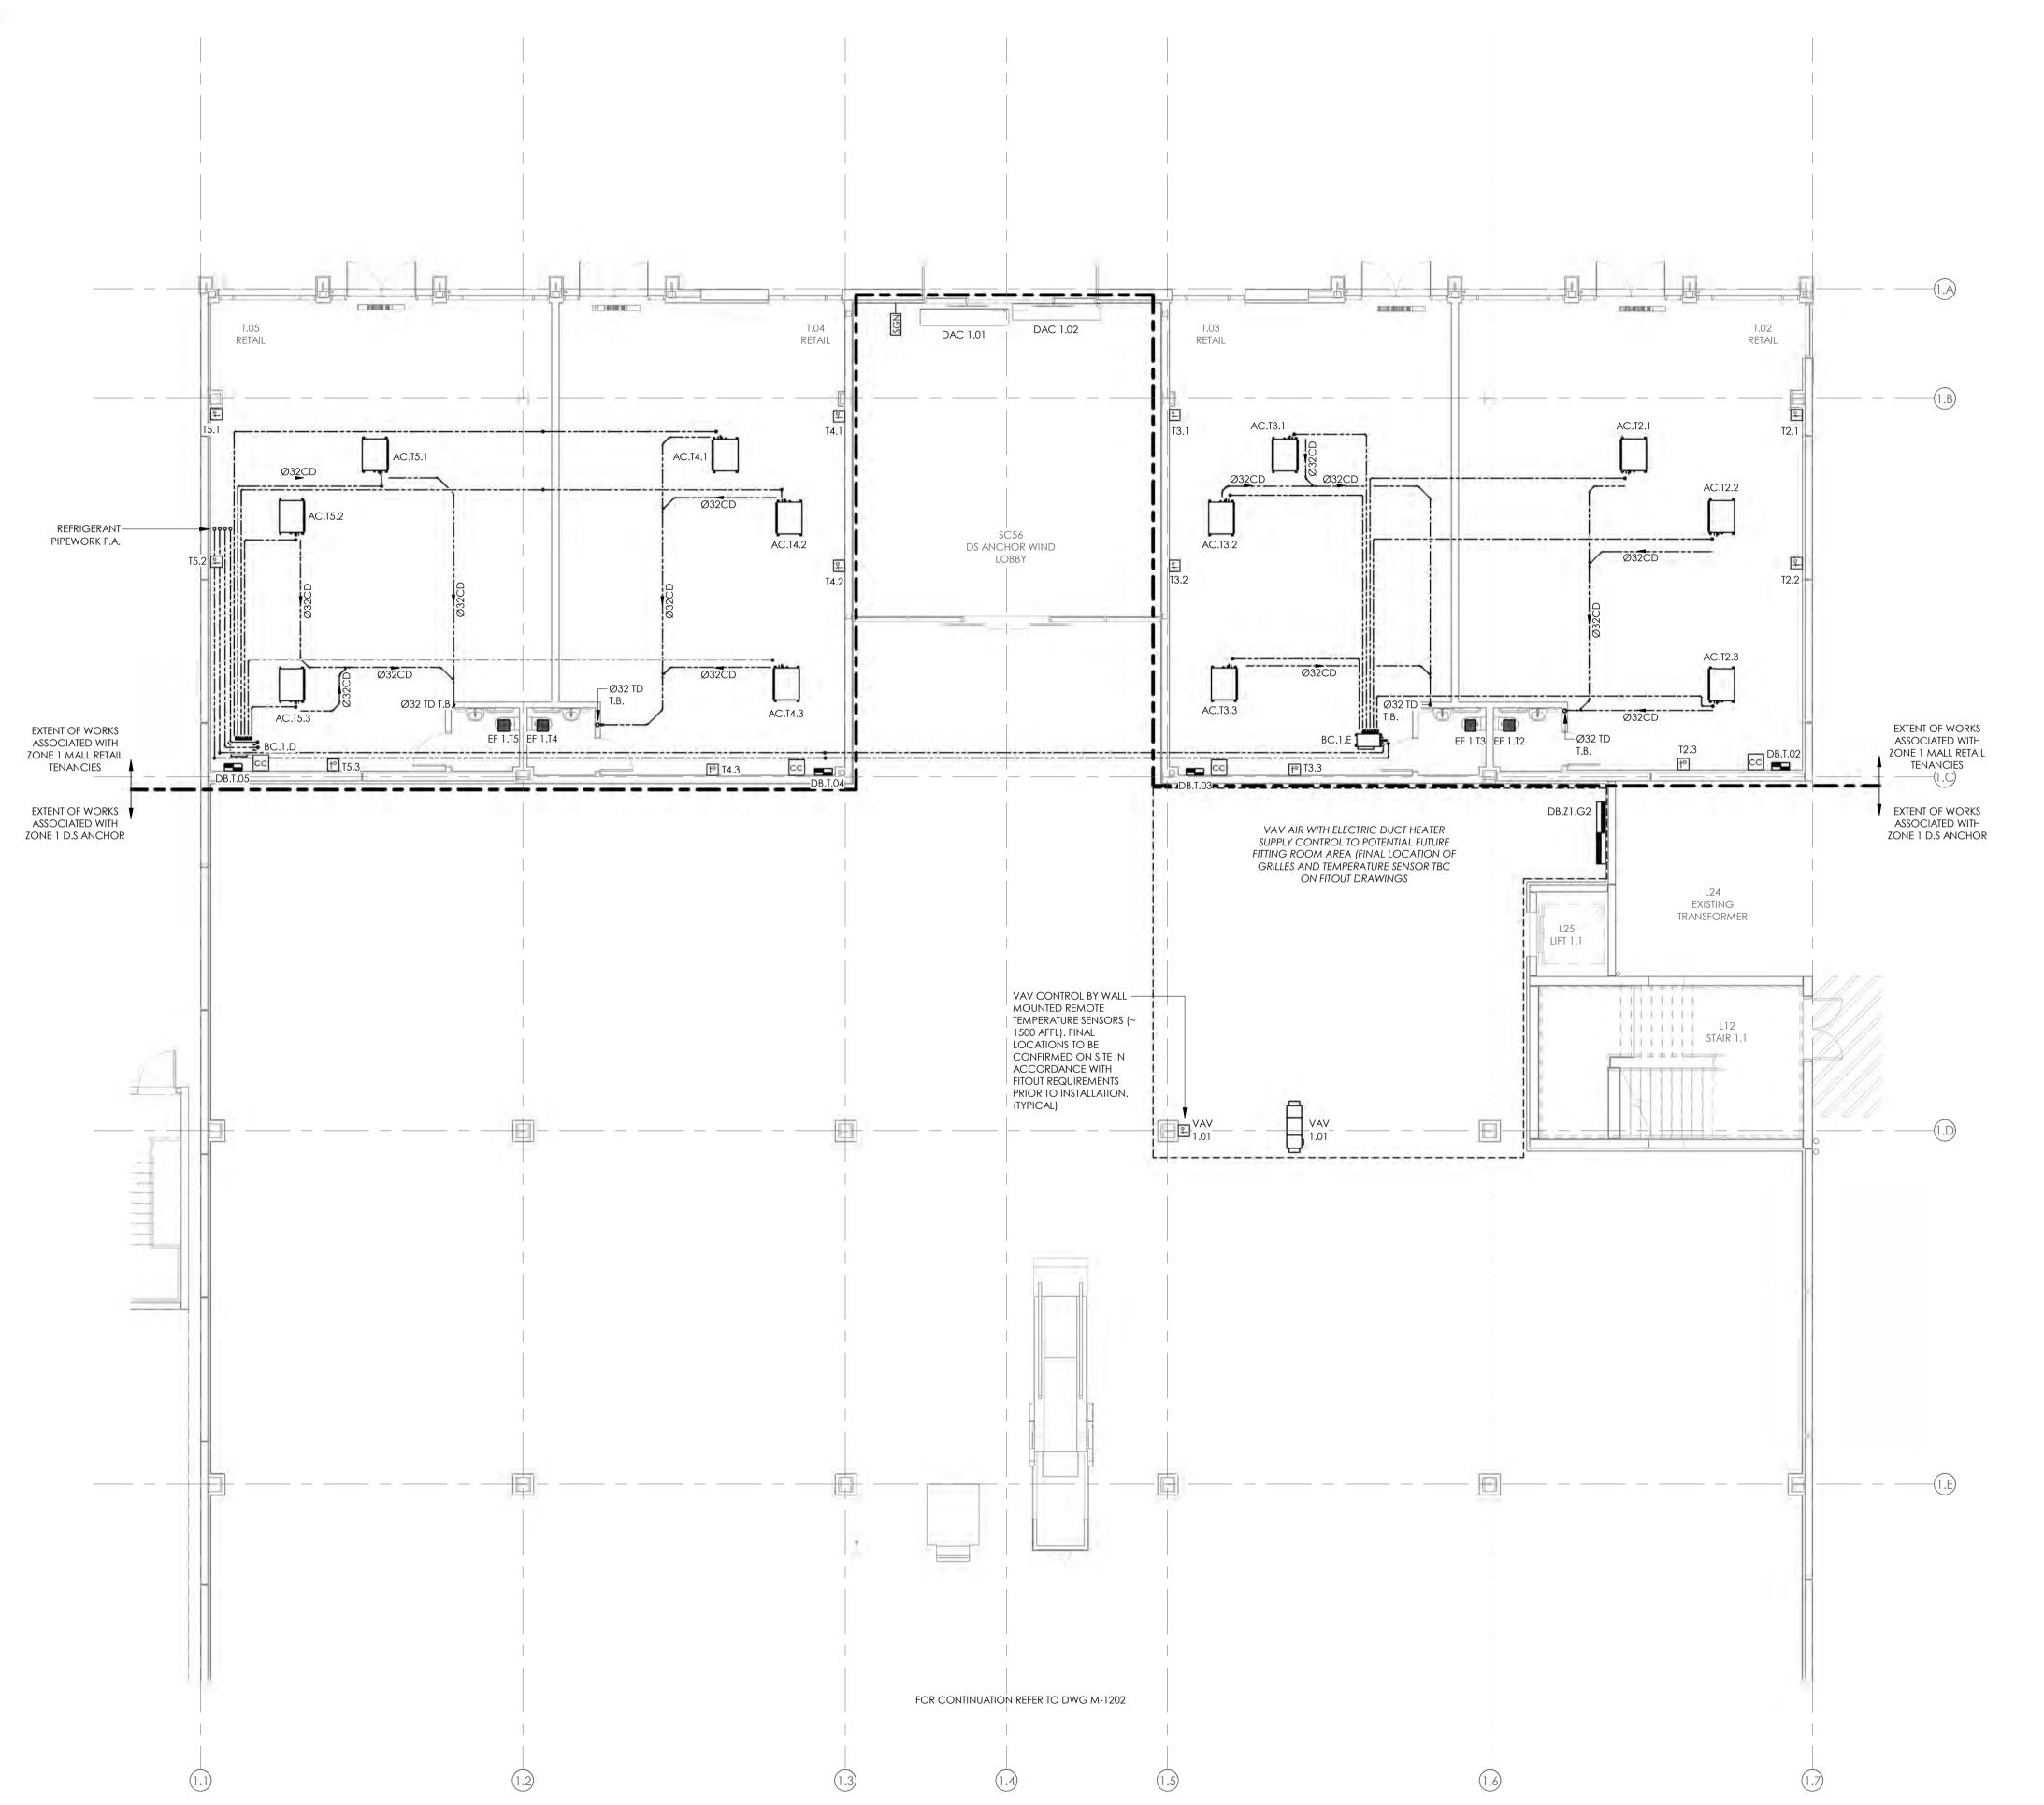
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INVERCARGILL CENTRAL 33 ESK STREET ZONE 1

PIPEWORK & CONTROLS LAYOUT GROUND FLOOR PART 1

CONSENT DESIGNED: SF DATE:

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- I. REFER TO FIRE ENGINEERS REPORT FOR EXTENT OF FIRE SEPERATIONS AND ALLOW TO SEAL ALL PENETRATIONS THROUGH FIRE RATED BUILDING FIRMENTS
- ALL D.S ANCHOR ROOFTOP PLANT AND CONTROLS SHALL BE PROVIDED WITH SUITABLE BACNET INTERFACE CARDS FOR CONNECTION TO THE D.S.ANCHOR BUILDING MANAGEMENT SYSTEM (BMS.F, LOCATED IN THE ZONE 1 GROUND LEVEL MAIN SWITCHBOARD ROOM) VIA D.S.ANCHOR LOCAL BACNET ETHERNET NETWORK TO ALLOW FOR REMOTE MONITORING AND ADJUSTMENT.
- ALL PLANT AND CONTROLS SERVING INVERCARGILL CENTRAL MALL RETAIL TENANCIES SHALL BE PROVIDED WITH SUITABLE BACNET INTERFACE CARDS FOR CONNECTION TO THE INVERCARGILL CENTRAL MALL BUILDING MANAGEMENT SYSTEM (BMS-M, TO BE LOCATED IN ZONE 2, LEVEL 1 CENTRE MANAGEMENT OFFICES) VIA SEPERATE MALL BACNET ETHERNET NETWORK TO ALLOW FOR REMOTE MONITORING AND ADJUSTMENT.

| B A | CONSENT ISSUE COORDINATION ISSUE | 11.10.19 27.09.19 |
|--------|----------------------------------|----------------------|
| ISSUE | | DATE |

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PROJECT


INVERCARGILL CENTRAL 33 ESK STREET ZONE 1

SHEET TITLE:

PIPEWORK & CONTROLS LAYOUT GROUND FLOOR PART 2

| | C | ONSENT | |
|-------|-------|----------|--|
| D: SF | DATE: | 11 10 19 | |

PROJECT NO: CS18007-1

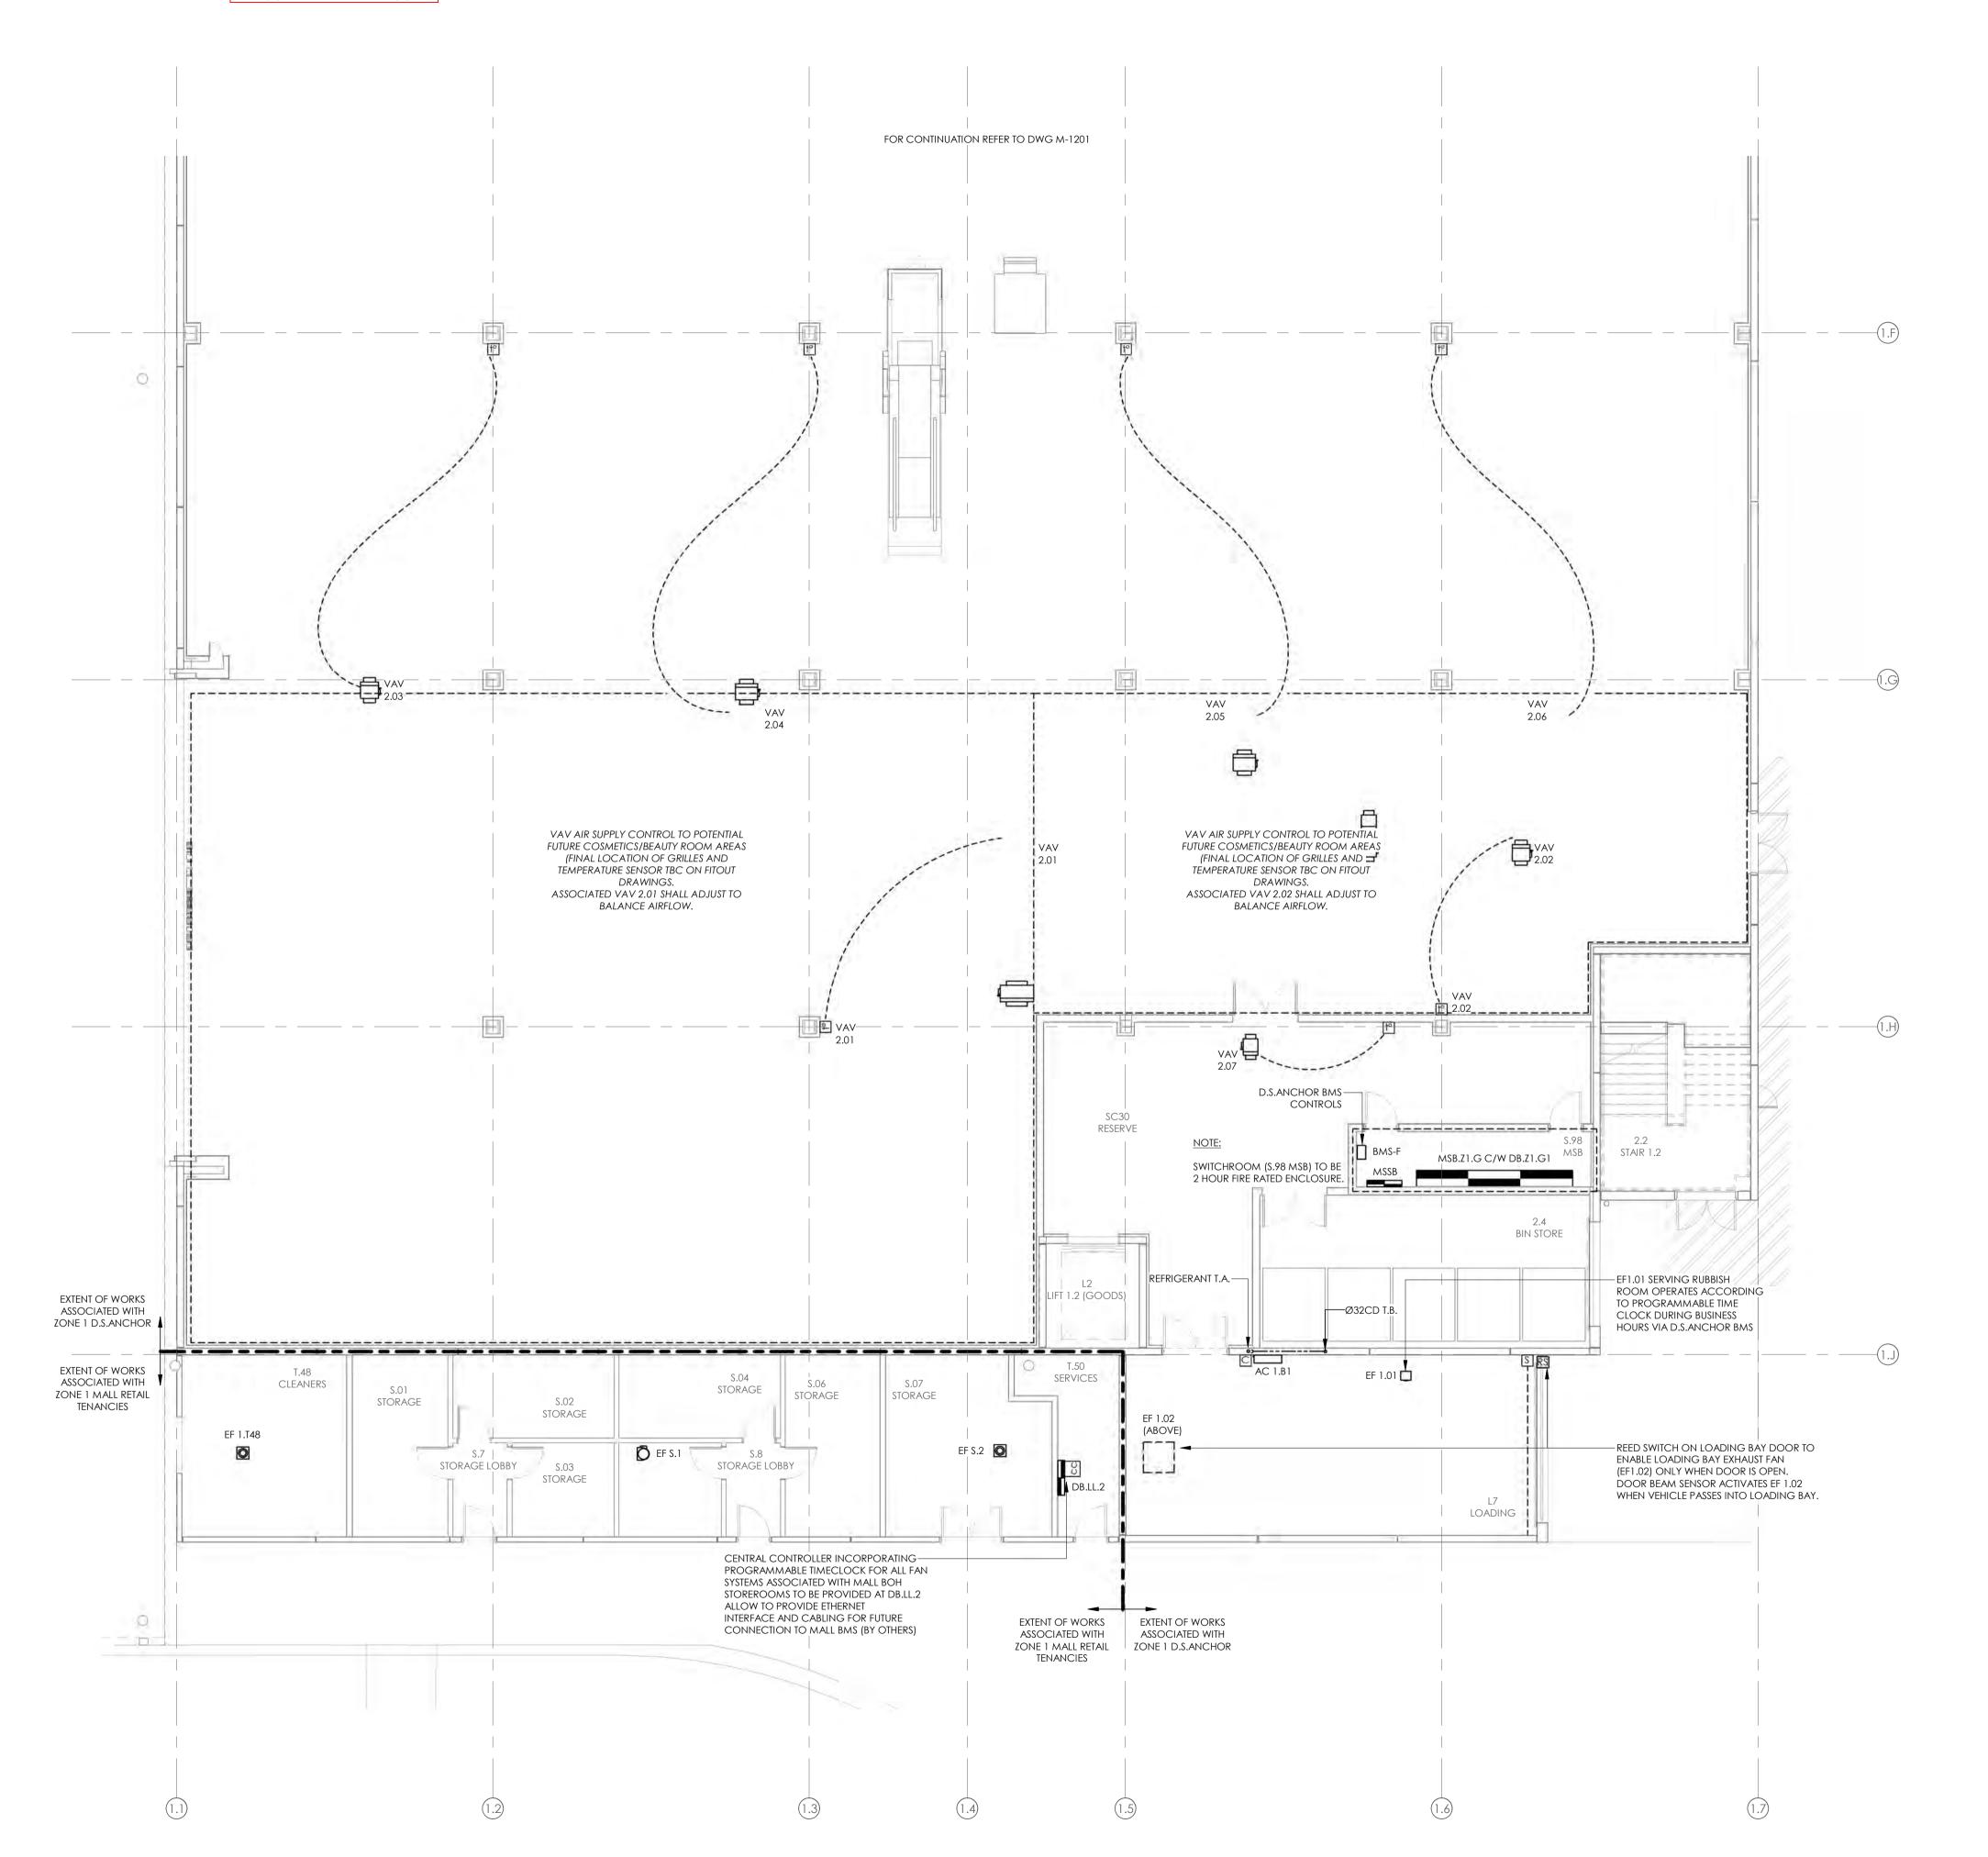

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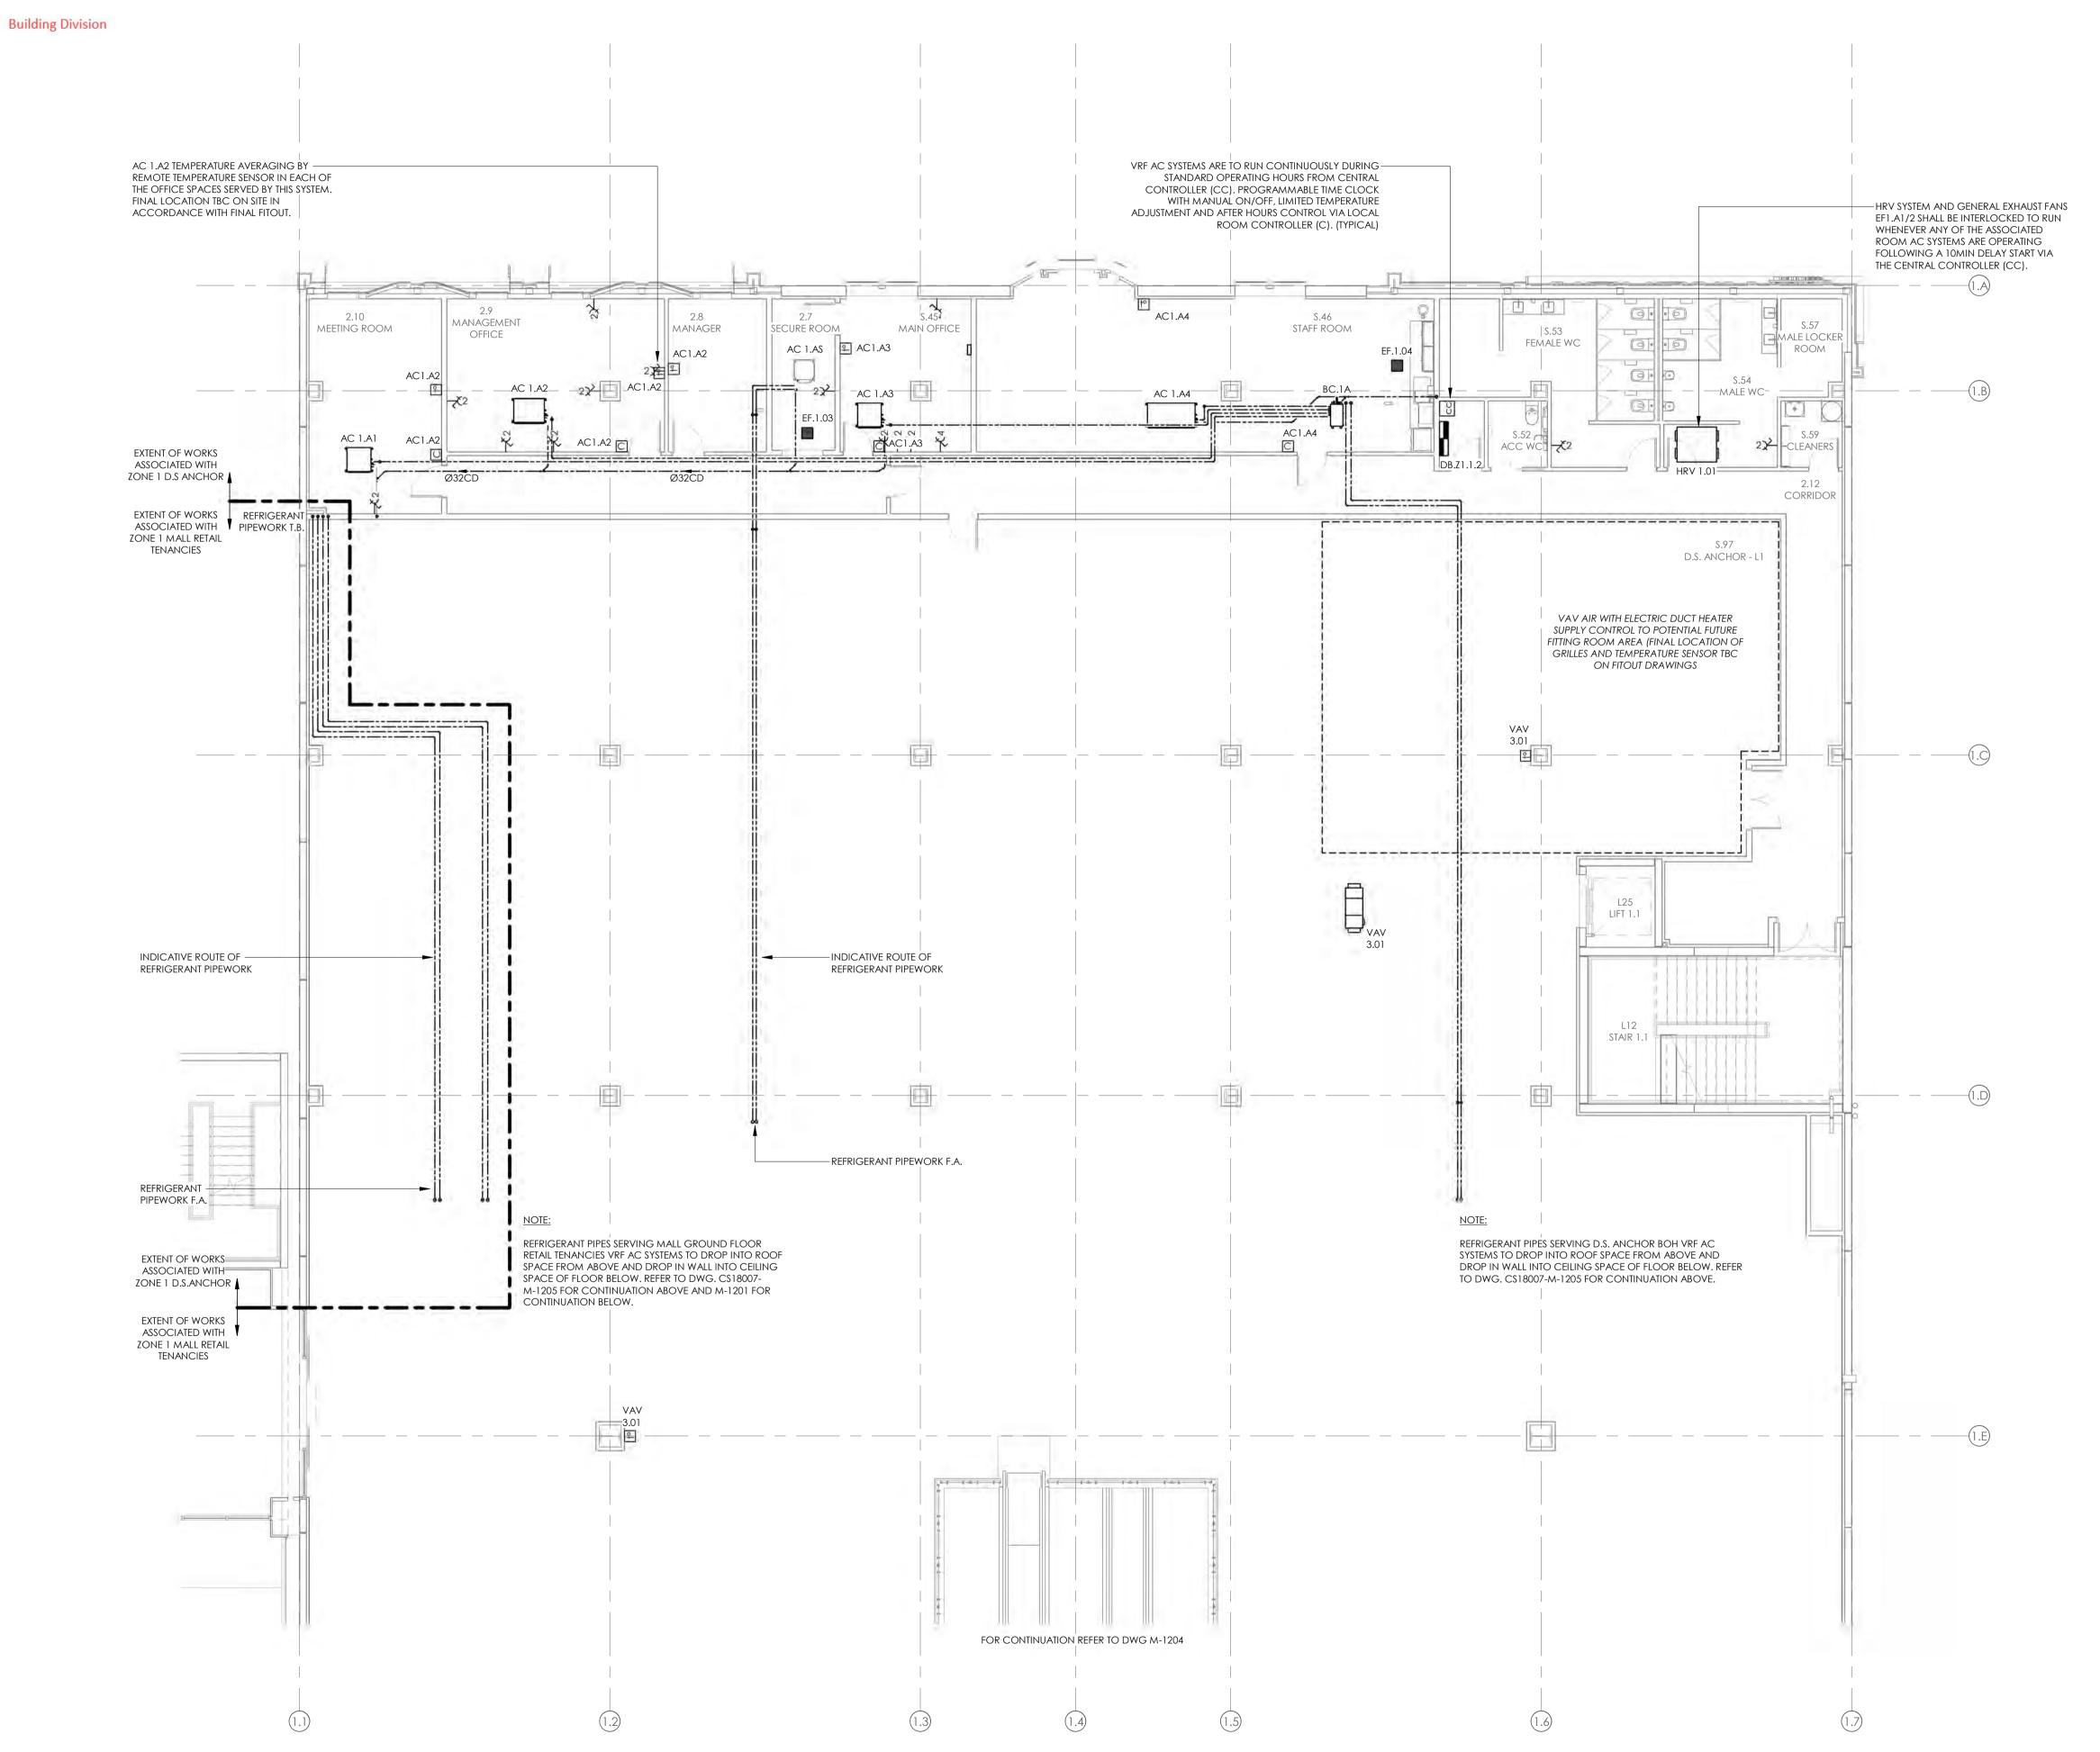
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- REFER TO FIRE ENGINEERS REPORT FOR EXTENT OF FIRE SEPERATIONS AND ALLOW TO SEAL ALL PENETRATIONS THROUGH FIRE RATED BUILDING ELEMENTS.
- ALL D.S ANCHOR ROOFTOP PLANT AND CONTROLS SHALL BE PROVIDED WITH SUITABLE BACNET INTERFACE CARDS FOR CONNECTION TO THE D.S ANCHOR BUILDING MANAGEMENT SYSTEM (BMS.F, LOCATED IN THE ZONE 1 GROUND LEVEL MAIN SWITCHBOARD ROOM) VIA D.S ANCHOR LOCAL BACNET ETHERNET NETWORK TO ALLOW FOR REMOTE MONITORING AND ADJUSTMENT.



B CONSENT ISSUE 11.10.19
A COORDINATION ISSUE 27.09.19
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ROJECT

INVERCARGILL CENTRAL 33 ESK STREET ZONE 1

SHEET TITL

PIPEWORK & CONTROLS LAYOUT LEVEL 1 PART 1

CONSENT

DESIGNED: SF DATE: 11.10.19

DRAWN: RC SCALE @ A1: 1:100

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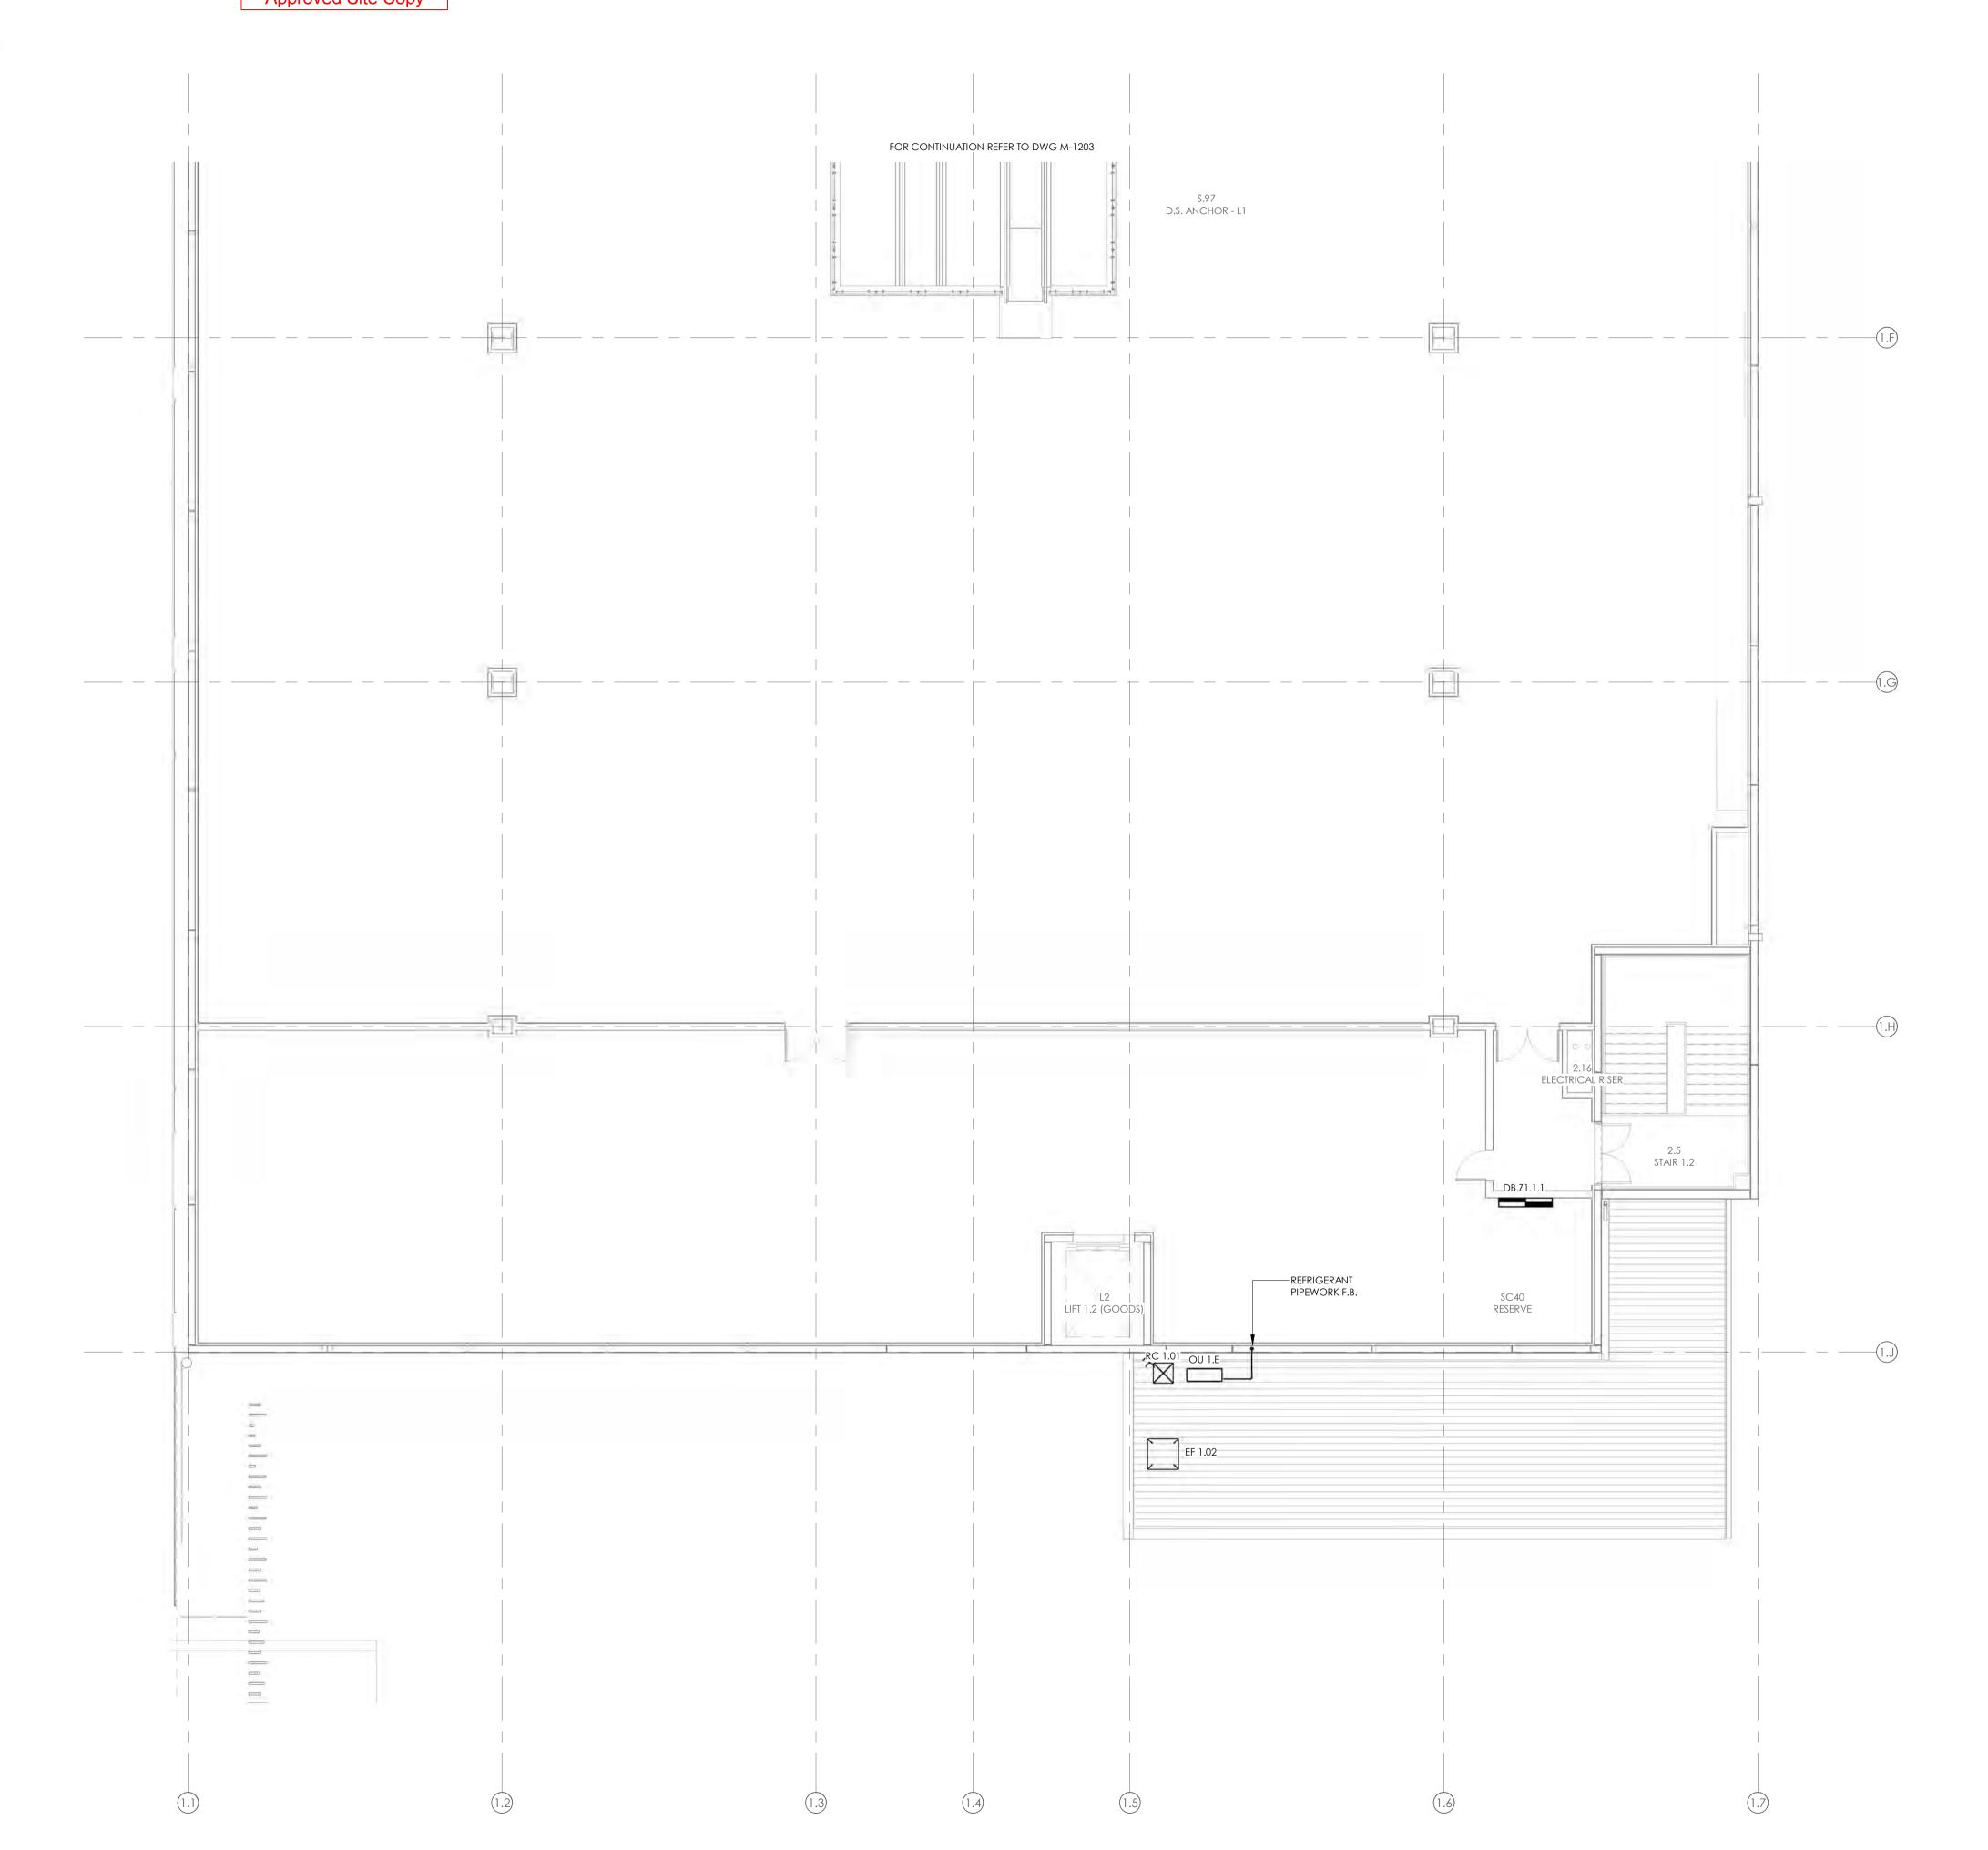
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ALL D.S ANCHOR ROOFTOP PLANT AND CONTROLS SHALL BE PROVIDED WITH SUITABLE BACNET INTERFACE CARDS FOR CONNECTION TO THE D.S ANCHOR BUILDING MANAGEMENT SYSTEM (BMS.F, LOCATED IN THE ZONE 1 GROUND LEVEL MAIN SWITCHBOARD ROOM) VIA D.S.ANCHOR LOCAL BACNET ETHERNET NETWORK TO ALLOW FOR REMOTE MONITORING AND ADJUSTMENT.



11.10.19 27.09.19 **DATE** A COORDINATION ISSUE AMENDMENT

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INVERCARGILL CENTRAL 33 ESK STREET ZONE 1

PIPEWORK & CONTROLS LAYOUT LEVEL 1 PART 2

| CONSENT |
|---------|
| |

DESIGNED: SF DATE: 11.10.19 DRAWN: RC | SCALE @ A1: 1:100

CS18007-1

17 Dec 2019

REFRIGERANT PIPES SERVING CHILDCARE

VRF AC SYSTEMS TO RISE ON EXTERNAL

WALL BEFORE ENTERING INTO ROOF

SPACE AT HIGH LEVEL WITH FLEXIBLE JOINTS AT PENETRATION

EXTENT OF WORKS ASSOCIATED WITH ZONE 1 CHILDCARE

EXTENT OF WORKS
ASSOCIATED WITH
ZONE 1 D.S ANCHOR

Building Division

Invercargill City
Council
Building Consent
Authority
Approved Site Copy

Approved For Issue 27/02/2020

004044004

BUILDING CONSENT NUMBER

NOTE

REFER TO DRAWING M001 FOR STANDARD SYMBOLS LEGEND & DETAILS

REFER TO MECHANICAL SERVICES SPECIFICATION FOR FURTHER DETAILS.

- AC AND HEATING SYSTEMS CONTROLS AND REMOTE TEMPERATURE SENSORS TO TYPICALLY BE INSTALLED AT 1200AFFL TO BOTTOM EDGE OF DEVICE. FINAL LOCATIONS TO BE CONFIRMED ON SITE PRIOR TO INSTALLATION TO TAKE ACCOUNT OF FINAL FITOUT LAYOUTS.
- REFER TO FIRE ENGINEERS REPORT FOR EXTENT OF FIRE SEPERATIONS AND ALLOW TO SEAL ALL PENETRATIONS THROUGH FIRE RATED BUILDING ELEMENTS.
- ALL D.S ANCHOR ROOFTOP PLANT AND CONTROLS SHALL BE PROVIDED WITH SUITABLE BACNET INTERFACE CARDS FOR CONNECTION TO THE D.S ANCHOR BUILDING MANAGEMENT SYSTEM (BMS.F, LOCATED IN THE ZONE 1 GROUND LEVEL MAIN SWITCHBOARD ROOM) VIA D.S ANCHOR LOCAL BACNET ETHERNET NETWORK TO ALLOW FOR REMOTE MONITORING AND ADJUSTMENT.
- ALL CHILDCARE CENTRE PLANT AND CONTROLS SHALL BE PROVIDED WITH SUITABLE BACNET INTERFACE CARDS FOR CONNECTION TO THE INVERCARGILL CENTRAL MALL BUILDING MANAGEMENT SYSTEM (BMS-M, TO BE LOCATED IN ZONE 2, LEVEL 1 CENTRE MANAGEMENT OFFICES) VIA SEPERATE MALL BACNET ETHERNET NETWORK TO ALLOW FOR REMOTE MONITORING AND ADJUSTMENT.
- HRV SYSTEMS AND WC EXHAUST FANS ARE TO RUN CONTINUOUSLY DURING STANDARD OPERATING HOURS FROM CENTRAL CONTROLLER (CC) PROGRAMMABLE TIME CLOCK.
- ELECTRIC PANEL HEATERS AND AC SYSTEMS ARE TO RUN CONTINUOUSLY DURING STANDARD OPERATING HOURS FROM CENTRAL CONTROLLER (CC) PROGRAMMABLE TIME CLOCK WITH MANUAL ON/OFF, LIMITED TEMPERATURE ADJUSTMENT AND AFTER HOURS CONTROL VIA LOCAL ROOM CONTROLLER.
- LAUNDRY EXHAUST FAN SHALL BE INTERLOCKED TO RUN VIA CURRENT SWITCH AT DRYER POWER SUPPLY POINT WHENEVER DRYER IS OPERATING.

B CONSENT ISSUE 11.10.19
A COORDINATION ISSUE 27.09.19
SSUE AMENDMENT DATE

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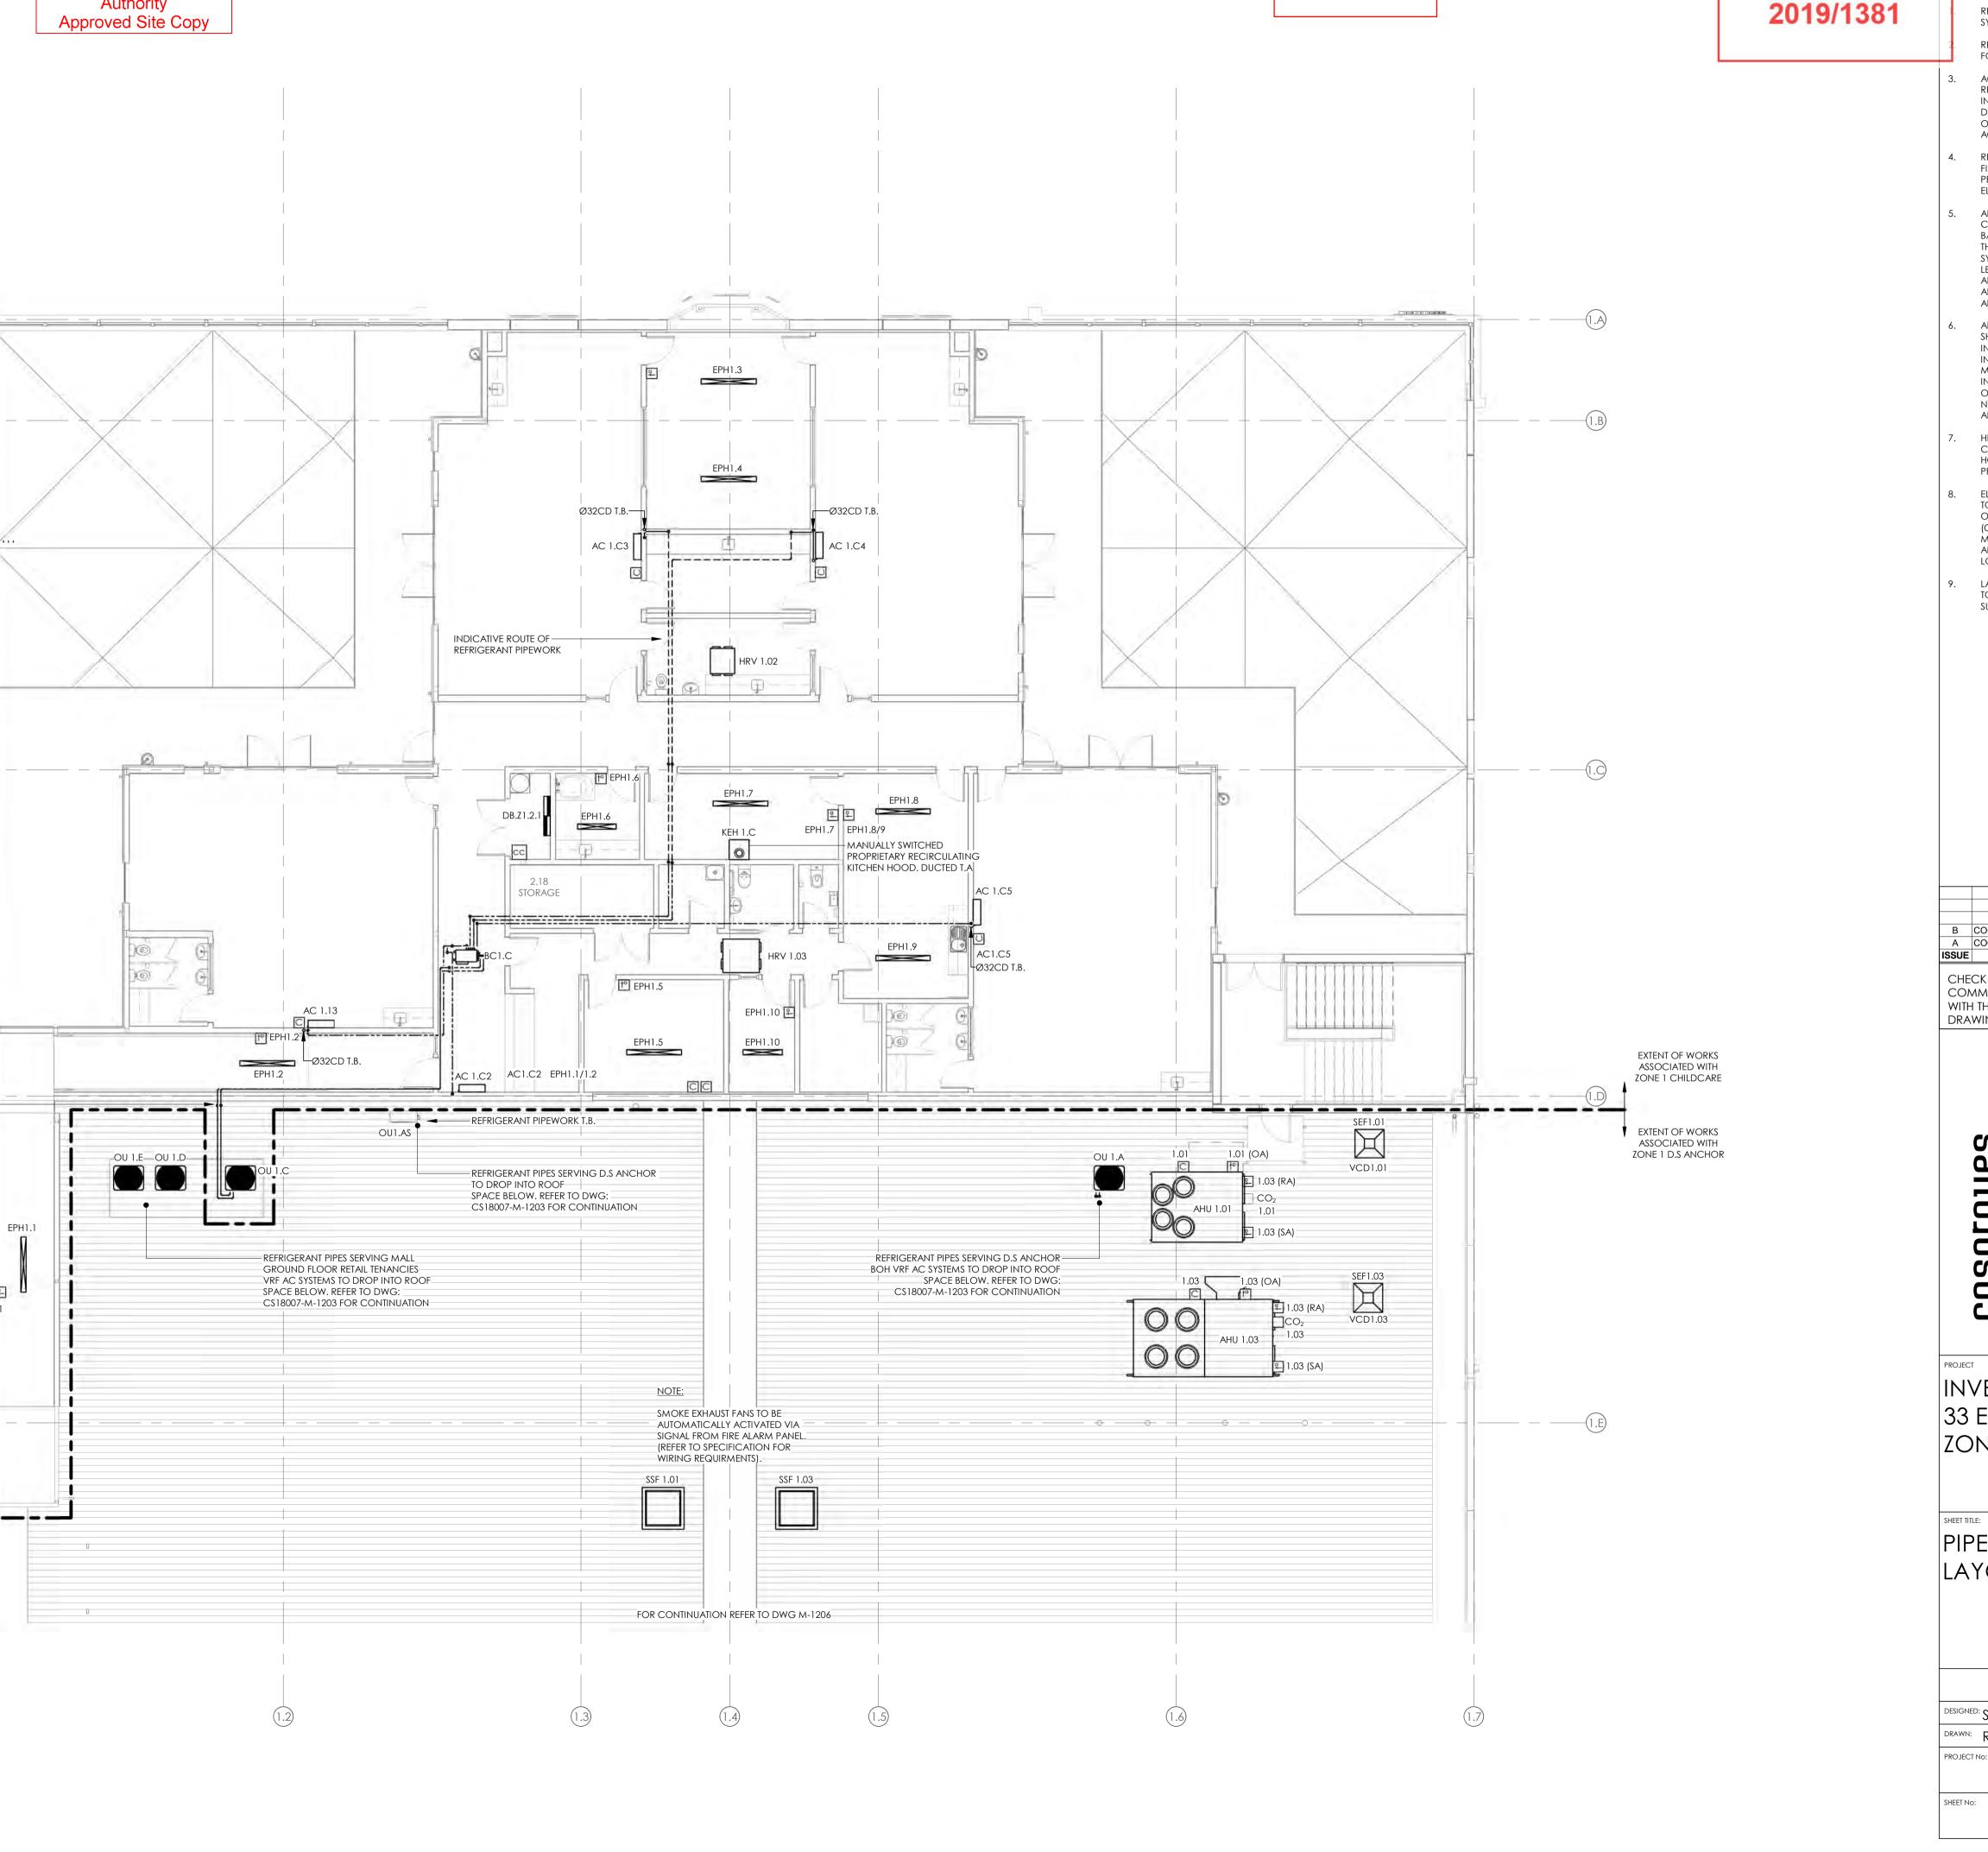
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INVERCARGILL CENTRAL 33 ESK STREET ZONE 1

PIPEWORK & CONTROLS LAYOUT LEVEL 2 PART 1

CONSENT

PROJECT NO: CS18007-1



17 Dec 2019

Building Division

Invercargill City Council **Building Consent** Authority Approved Site Copy Approved For Issue 27/02/2020


BUILDING CONSENT NUMBER

2019/1381

REFER TO DRAWING M001 FOR STANDARD SYMBOLS LEGEND & DETAILS

REFER TO MECHANICAL SERVICES SPECIFICATION FOR FURTHER DETAILS.

- AC AND HEATING SYSTEMS CONTROLS AND REMOTE TEMPERATURE SENSORS TO TYPICALLY BE INSTALLED AT 1200AFFL TO BOTTOM EDGE OF DEVICE. FINAL LOCATIONS TO BE CONFIRMED ON SITE PRIOR TO INSTALLATION TO TAKE ACCOUNT OF FINAL FITOUT LAYOUTS.
- REFER TO FIRE ENGINEERS REPORT FOR EXTENT OF FIRE SEPERATIONS AND ALLOW TO SEAL ALL PENETRATIONS THROUGH FIRE RATED BUILDING
- ALL D.S. ANCHOR ROOFTOP PLANT AND CONTROLS SHALL BE PROVIDED WITH SUITABLE BACNET INTERFACE CARDS FOR CONNECTION TO THE D.S. ANCHOR BUILDING MANAGEMENT SYSTEM (BMS.F, LOCATED IN THE ZONE 1 GROUND LEVEL MAIN SWITCHBOARD ROOM) VIA FARMERS LOCAL BACNET ETHERNET NETWORK TO ALLOW FOR REMOTE MONITORING AND ADJUSTMENT.

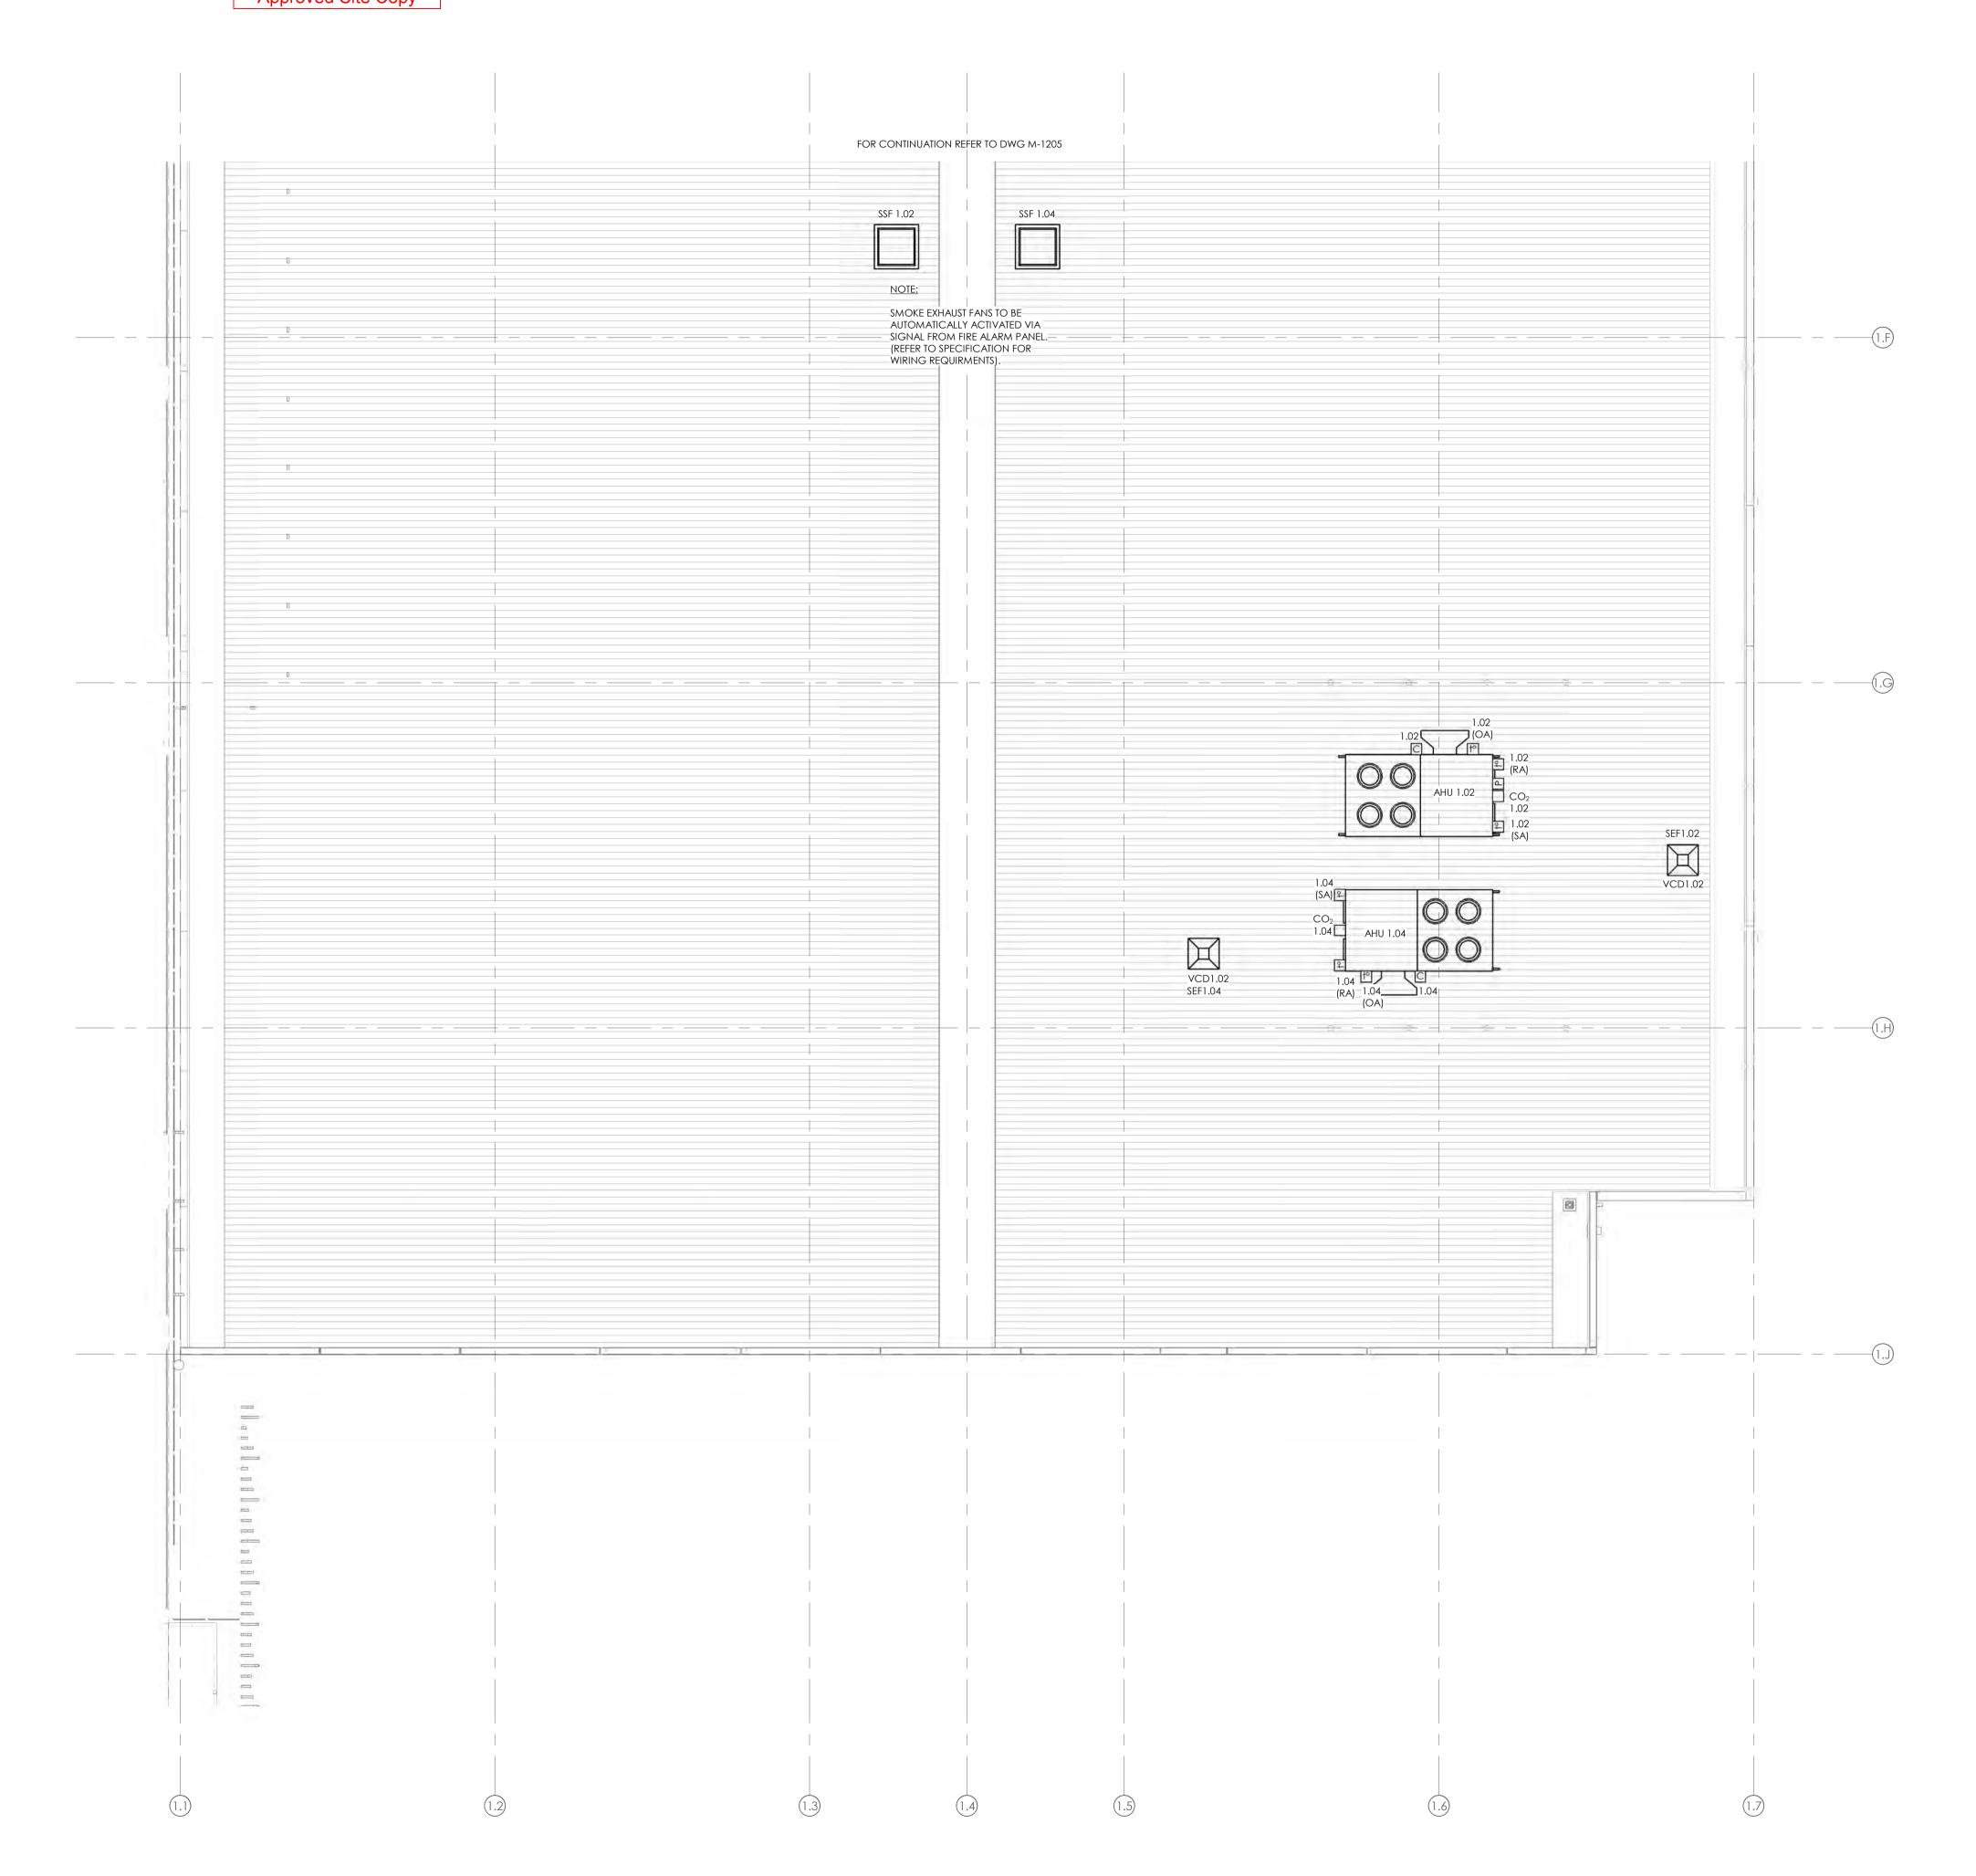

11.10.19 27.09.19 **DATE** A COORDINATION ISSUE AMENDMENT

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INVERCARGILL CENTRAL 33 ESK STREET ZONE 1

PIPEWORK & CONTROLS LAYOUT LEVEL 2 PART 2

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BUILDING CONSENT NUMBER


NOTE: SOME GRILLES/DIFFUSERS OMMITTED FOR **CLARITY AND DUCT ROUTES IN CEILING VOIDS ARE**

17 Dec 2019


Building Division

Department Store - Retail Shopfloor

Zone 1 South (Part 2) Zone 1 North (Part 1)

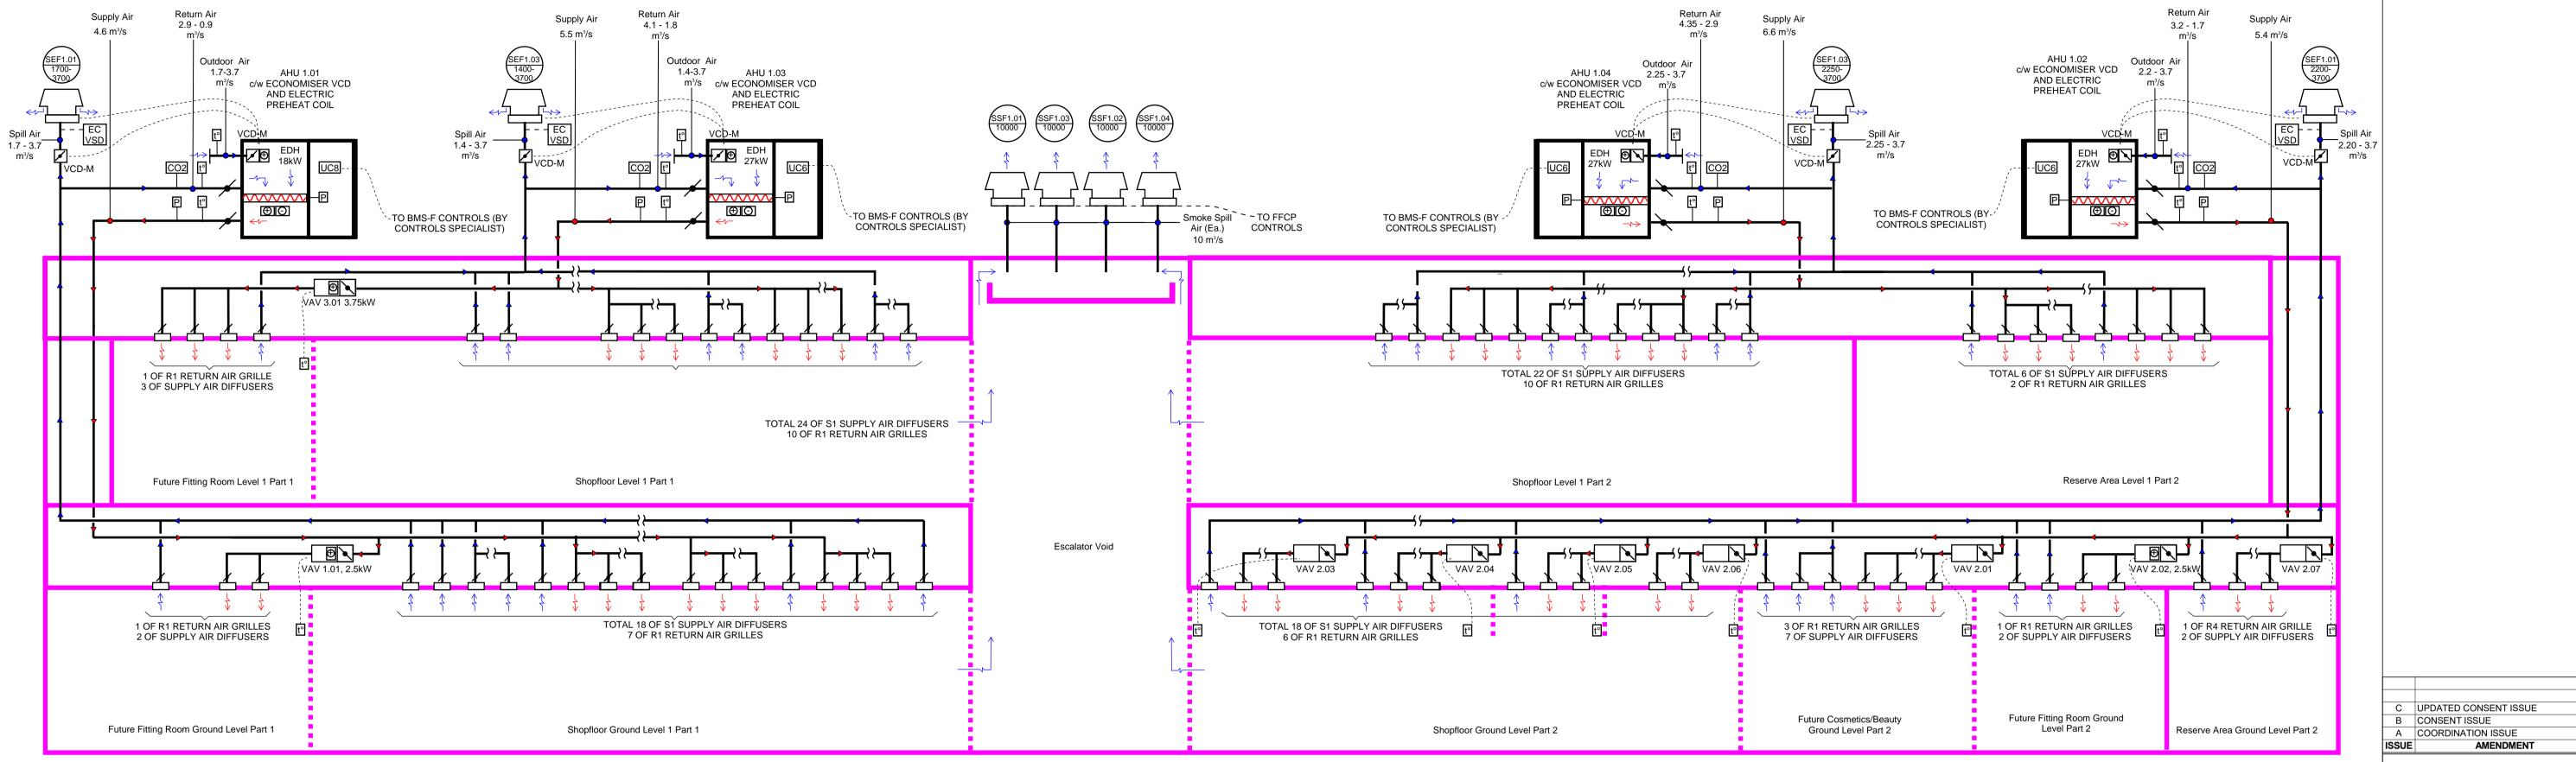



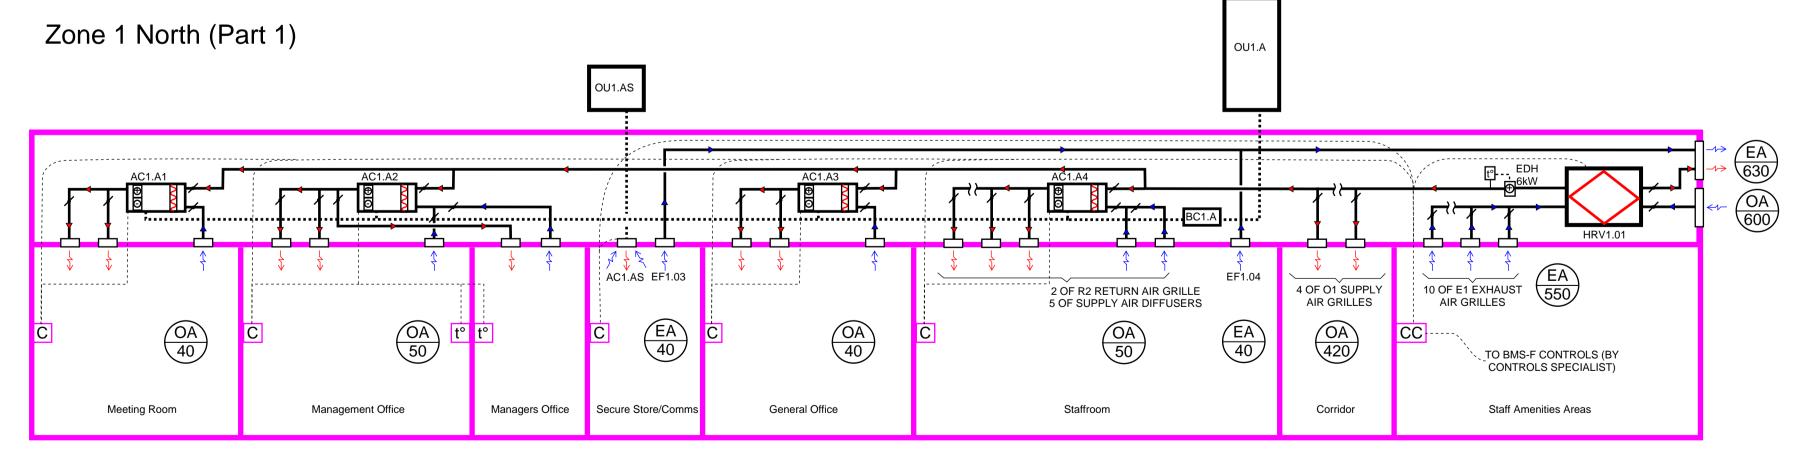

Farmers BOH Offices Level 1 Part 1

| ISSUE | AMENDMENT | DATE |
|-------|-----------------------|----------|
| Α | COORDINATION ISSUE | 27.09.19 |
| В | CONSENT ISSUE | 11.10.19 |
| С | UPDATED CONSENT ISSUE | 24.10.19 |
| | | |
| | | |

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INVERCARGILL CENTRAL 33 ESK STREET ZONE 1

MECHANICAL SCHEMATIC

UPDATED CONSENT DESIGNED: RA DATE: 24.10.19 DRAWN: RA SCALE @ A1:

CS18007-1


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Building Division


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- SMOKE EXTRACT FANS SHALL BE ACTIVATED VIA A SIGNAL FROM THE FIRE ALARM SYSTEM
 - TO THE FIRE FAN CONTROL PANEL. SMOKE EXTRACT FAN CONTROLS SHALL BE LOCATED IN THE MECHANICAL PANEL IN THE FIRE RATED ELECTRICAL SWITCH ROOM.
 - 4. REFER TO THE ENGINEERS FIRE STRATEGY REPORT FOR FURTHER INFORMATION.
 - 5. MAIN HVAC PLANT TO SHUT DOWN ON FIRE ALARM SIGNAL.



FOR INFORMATION AMENDMENT

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INVERCARGILL CENTRAL 33 ESK STREET ZONE 1

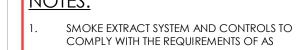FIRE SERVICES SMOKE EXTRACT AND CONTROL SYSTEMS DIAGRAM

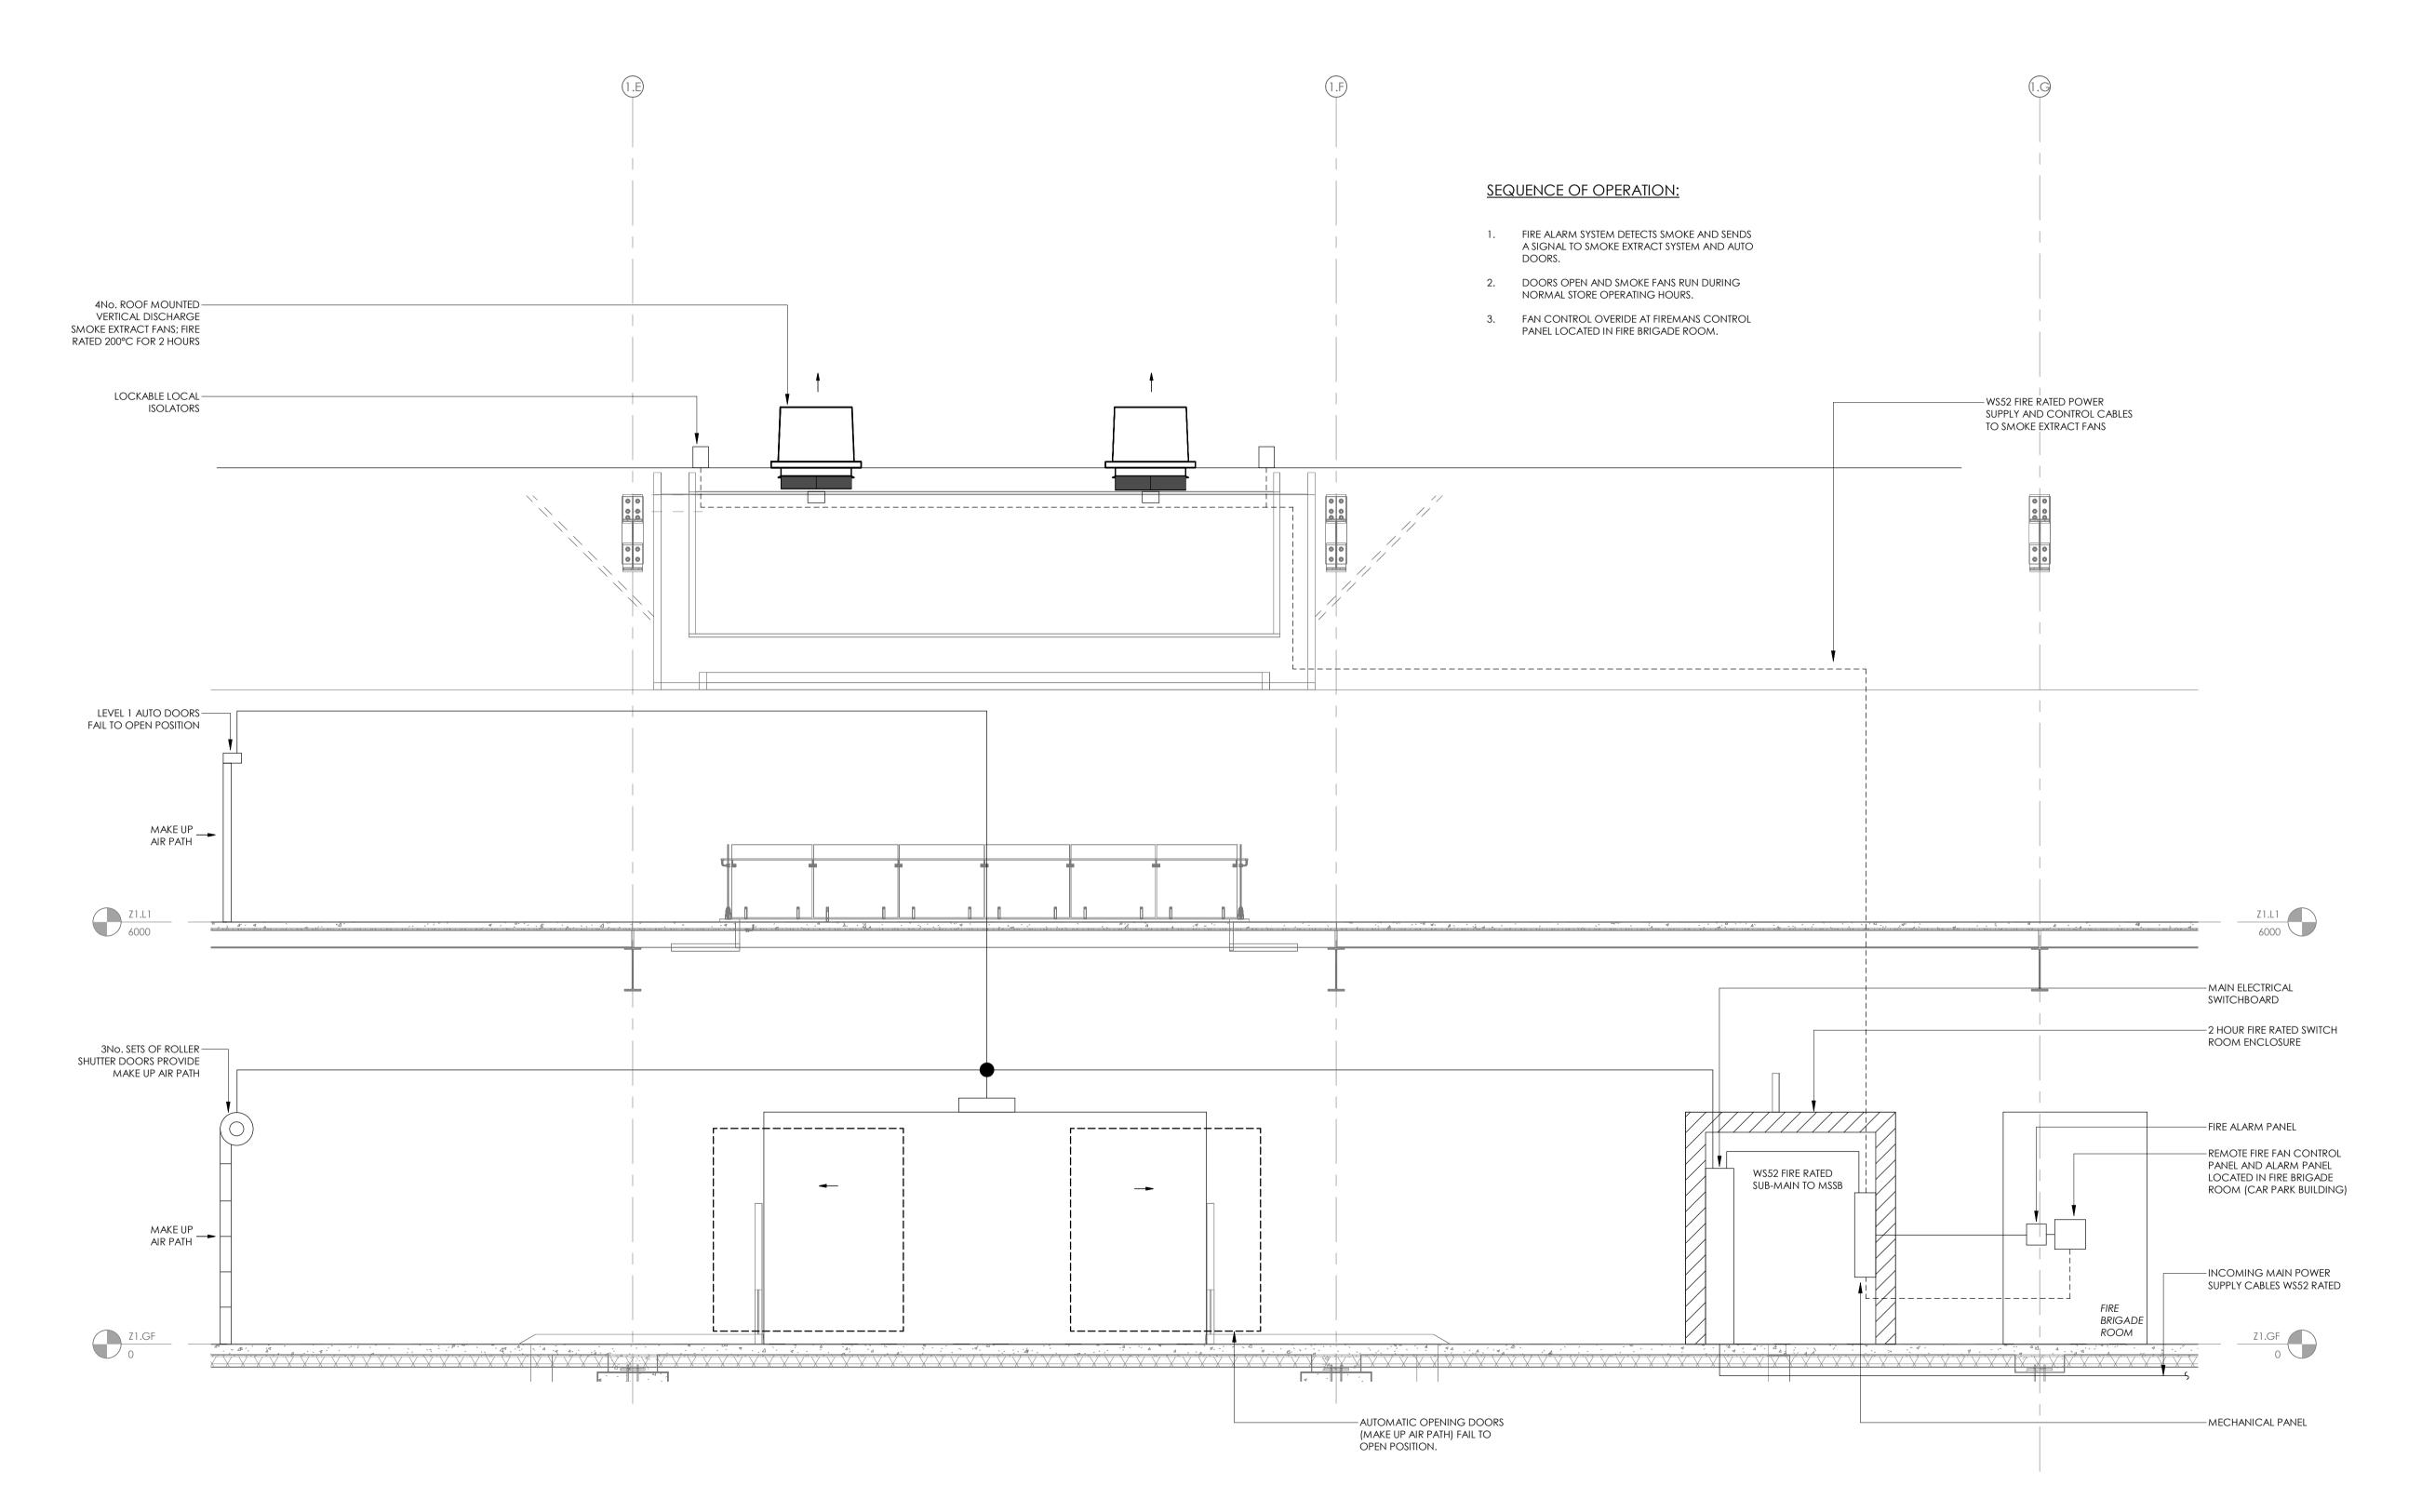FOR INFORMATION DESIGNED: SF DATE:

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